CITY OF SHINGTON KIRKLAND

116TH AVENUE NE/NE 124TH STREET INTERSECTION IMPROVEMENTS

JOB NO. 09-21-PW

OCTOBER, 2021


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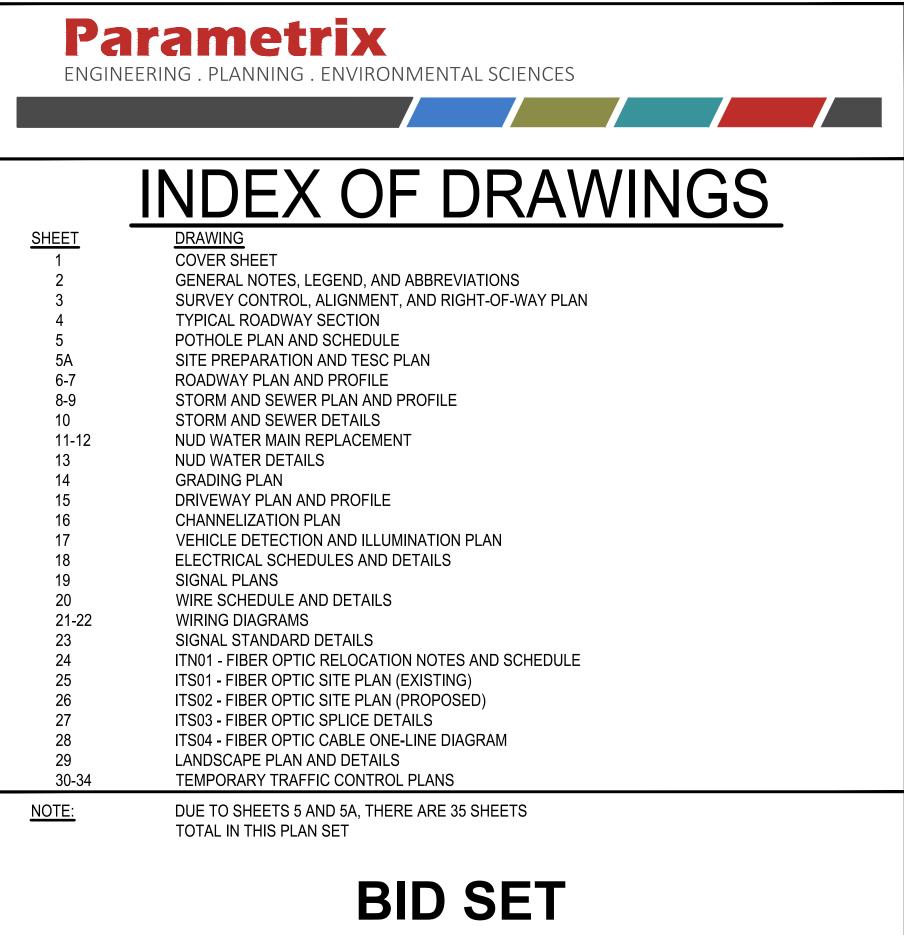
CITY OFFICIALS

JAY ARNOLD **DEPUTY MAYOR NEAL BLACK** COUNCIL MEMBER **KELLI CURTIS COUNCIL MEMBER AMY FALCONE** COUNCIL MEMBER **TOBY NIXON** COUNCIL MEMBER JON PASCAL COUNCIL MEMBER **KURT TRIPLETT** CITY MANAGER JULIE UNDERWOOD PUBLIC WORKS DIRECTOR ROD STEITZER, PE CAPITAL PROJECTS MANAGER

CONTACT PERSONNEL

<u>NAME</u>	AGENCY	<u>PHONE</u>
CATHERINE OKAMURA, PE	COK PROJECT ENGINEER	425.587.3832
STEVE HOOPES	COK FIELD REPRESENTATIVE	425.623.5086
RIK MAYER	COK FIELD REPRESENTATIVE	206.496.4265
BEN McVITTIE	COK FIELD REPRESENTATIVE	425.410.4606
RUS MANDERY	WSDOT CONSTRUCTION REPRESENTATIVE	206.327.1877
PATTY MILLER	PUGET SOUND ENERGY (GAS)	206.305.7950
FREMONT AGUINALDO	PUGET SOUND ENERGY (ELECTRIC)	425.223.0936
JOE FORDON	COMCAST CABLE	425.263.5348
JAY SCHWAB	ZIPLY FIBER	425.263.4019
SCOTT CHRISTENSON	VERIZON BUSINESS	425.471.1079
KELLY NESBITT - DISPATCH	NORTHSHORE UTILITY DISTRICT	425.398.4431
DAVE KAISER	NORTHSHORE UTILITY DISTRICT	425.419.8568
CONST. COORDINATOR	KING COUNTY METRO	206.477.1140
JEFF MILES	LAKE WASH. SCHOOL DISTRICT	425.936.1120
EMERGENCY	NORCOM	911
POLICE MAIN LINE	COK	425.587.3400
FIRE MAIN LINE	COK	425.864.3650
SPILL RESPONSE HOTLINE	COK	425.587.3900
ONE CALL UTILITY LOCATE		800.424.5555
CONSTRUCTION COORDINATOR	KCM	206.477.1140
METRO INSPECTOR	KCM	206.263.2381
KALE CHANG YUEN	KCM	206.263.0885
COLIN ASQUITH	KCM	206.477.5984



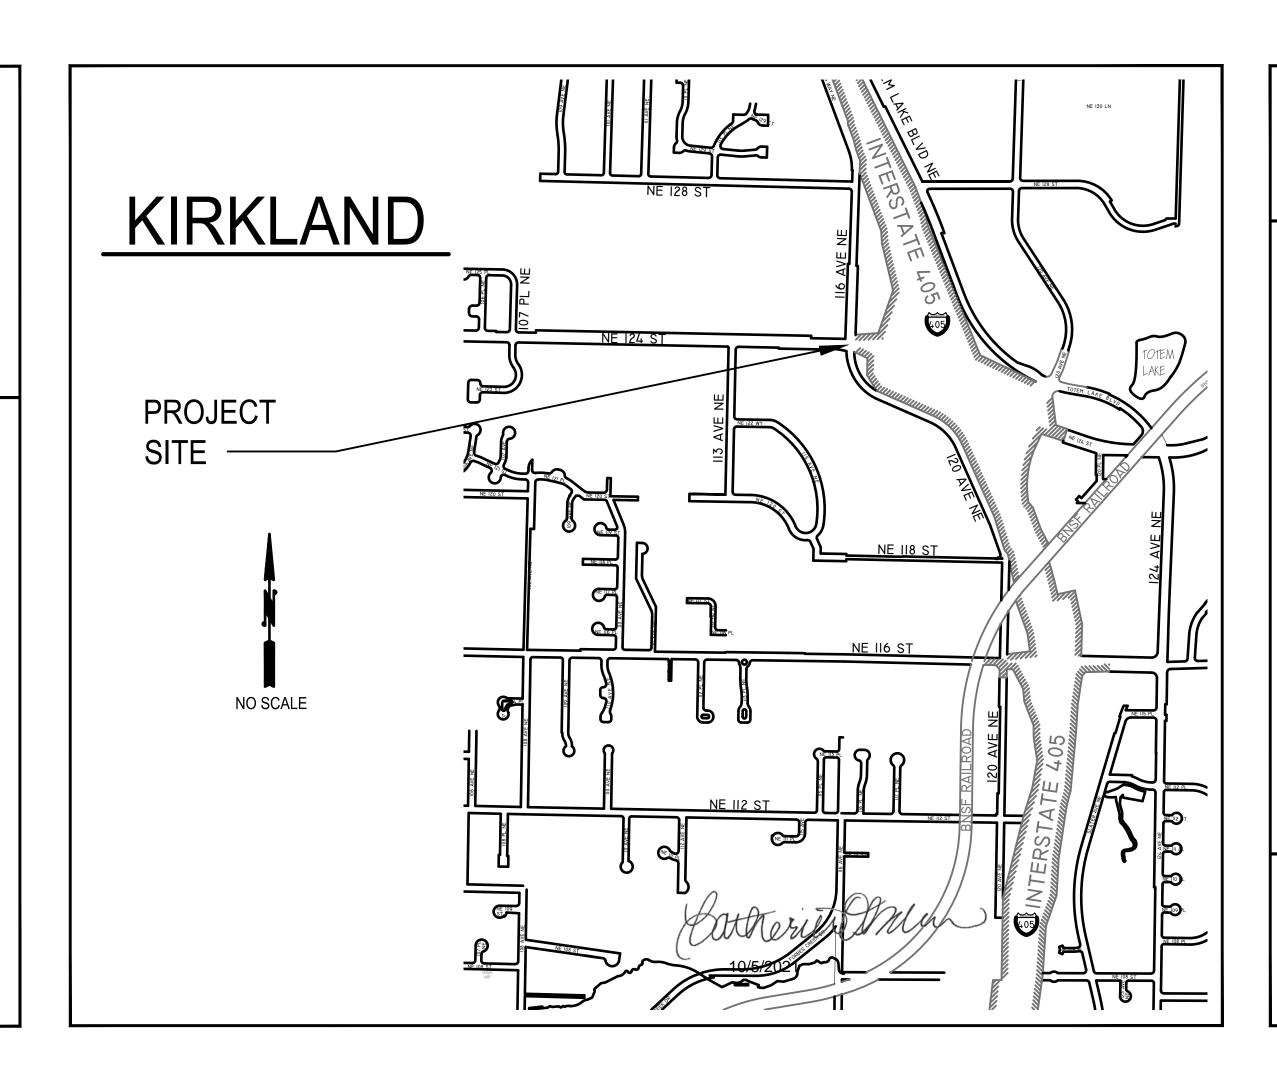

- ALL ROADWAY WORK AND MATERIAL SHALL BE IN ACCORDANCE WITH THE CURRENT APWA AND CITY OF KIRKLAND STANDARDS AND SPECIFICATIONS.
- 3. ALL PUBLIC ROADWAYS SHALL BE CONSTRUCTED OF 2" CLASS "B" AC PAVING ON 4" ASPHALT-TREATED BASE (ATB), UNLESS OTHERWISE APPROVED BY THE PUBLIC WORKS DEPARTMENT
- 4. A COPY OF THE APPROVED ROADWAY PLANS MUST BE ON THE JOB SITE WHENEVER CONSTRUCTION IS IN PROGRESS.
- DENSITY TEST REPORTS WILL BE REQUIRED FOR ALL PUBLIC ROADWAYS AND ALL PRIVATE ROADWAYS WITHIN PLATS. ALL TRENCH BACKFILL SHALL BE COMPACTED TO 95 PERCENT DENSITY IN ROADWAYS, ROADWAY SHOULDERS, ROADWAY PRISM AND DRIVEWAYS, AND 85 PERCENT DENSITY IN UNPAVED ALL PIPE ZONE COMPACTION SHALL BE 95 PERCENT.
- ALL COMMERCIAL AND RESIDENTIAL DRIVEWAYS MUST CONFORM TO THE CITY OF KIRKLAND DEPARTMENT OF PUBLIC WORKS DRIVEWAY POLICY.
- 7. ALL CONCRETE FOR SIDEWALKS AND CURB AND GUTTER MUST BE 4,000 PSI MINIMUM. (5-3/4 SACK
- IN THE CASE OF NEW ROAD CONSTRUCTION OR RECONSTRUCTION REQUIRING MAILBOXES TO BE MOVED OR REARRANGED, THE CONTRACTOR SHALL COORDINATE WITH THE U.S. POSTAL SERVICE FOR THE NEW LOCATION OF THE MAILBOX STRUCTURE.
- ANY ROADWAY SIGNAGE OR STRIPING REMOVED OR TEMPORARILY MOVED BY THE CONTRACTOR SHALL BE RESTORED TO MEET THE CURRENT CITY OF KIRKLAND STANDARDS.
- 10. IT IS THE RESPONSIBILITY OF THE CONTRACTOR TO PROVIDE ADEQUATE TEMPORARY TRAFFIC CONTROL TO ENSURE TRAFFIC SAFETY DURING CONSTRUCTION ACTIVITIES. THEREFORE, THE CONTRACTOR SHALL SUBMIT A TRAFFIC CONTROL PLAN TO THE PUBLIC WORKS DEPARTMENT AT LEAST 48 HOURS PRIOR TO STARTING ANY WORK IN THE RIGHT-OF-WAY. ALL TRAFFIC CONTROL DEVICES SHALL CONFORM TO THE "MANUAL ON UNIFORM TRAFFIC CONTROL DEVICES" (MUTCD) OR AS MODIFIED BY THE TRAFFIC ENGINEER.
- 11. WHERE A SIDEWALK IS TO BE CONSTRUCTED ABOVE A SLOPE OR ADJACENT TO A ROCKERY OR RETAINING WALL WHERE THE LOWEST FINISHED ELEVATION OF THE SLOPE, ROCKERY, OR RETAINING WALL IS TO BE THIRTY INCHES (30") OR MORE BELOW THE FINISHED ELEVATION OF THE SIDEWALK, A SAFETY RAILING SHALL BE REQUIRED WHEN: (A) THE PLANE OF THE WALL FACE IS LESS THAN 4' IN HORIZONTAL DISTANCE FROM THE OUTSIDE EDGE OF THE SIDEWALK; (B) THE SLOPES ADJACENT TO THE SIDEWALK AVERAGE GREATER THAN TWO TO ONE.
- 12. THE MAXIMUM GRADE FOR PRIVATE ROADWAYS SHALL BE TWENTY PERCENT (20%), OR FIFTEEN PERCENT (15%) IF USED FOR FIRE ACCESS. FOR PUBLIC ROADWAYS, THE MAXIMUM GRADE SHALL BE FIFTEEN PERCENT (15%).
- 13. DEAD-END STREETS SHALL BE APPROPRIATELY SIGNED AND BARRICADED. SEE MOST CURRENT EDITION OF THE MUTCD.
- 14. SIDEWALK AND CURB AND GUTTER CANNOT BE POURED MONOLITHICALLY, THERE MUST BE A COLD JOINT OR FULL-DEPTH EXPANSION JOINT BETWEEN THEM.
- 15. MEASURES SHALL BE TAKEN BY THE CONTRACTOR TO PROVIDE GROUND COVER IN AREAS WITHIN THE RIGHT-OF-WAY WHICH HAVE BEEN STRIPPED OF NATURAL VEGETATION OR HAVE A POTENTIAL FOR EROSION.
- 16. THE CONTRACTOR SHALL COORDINATE WITH PUGET POWER FOR THE DESIGN AND INSTALLATION OF STREET LIGHTS ON ALL NEWLY-CREATED PUBLIC ROADWAYS AND EXISTING ROADWAYS.
- 17. WHEN AN EXISTING ROADWAY IS TO RECEIVE A HALF-STREET OVERLAY, THE EXISTING ROADWAY MUST BE COLD PLANED AT THE EDGE OF THE GUTTER AND CENTERLINE. WHEN THE EXISTING ROADWAY IS TO RECEIVE A FULL-STREET OVERLAY, IT MUST BE COLD PLANED AT THE EDGE OF BOTH GUTTERS. SEE CITY OF KIRKLAND STANDARD DETAIL NO. R.13.
- 18. ALL NEW SIGNS REQUIRED IN THE PUBLIC RIGHT-OF-WAY MUST BE PURCHASED FROM, AND INSTALLED BY. THE CITY OF KIRKLAND PUBLIC WORKS DEPARTMENT
- 19. WHEN INSTALLING NEW SIDEWALK, THE AREA BEHIND THE SIDEWALK MUST BE GRADED SO THAT THE YARD DRAINAGE DOES NOT DRAIN OVER THE SIDEWALK.
- 20. ANY EXISTING PUBLIC IMPROVEMENTS DAMAGED DURING CONSTRUCTION SHALL BE REPLACED PRIOR TO FINAL INSPECTION.
- 21. THE CONTRACTOR IS RESPONSIBLE FOR KEEPING ALL PUBLIC STREETS FREE FROM MUD AND DEBRIS AT ALL TIMES. THE CONTRACTOR SHALL BE PREPARED TO USE POWER SWEEPERS OR OTHER PIECES OF EQUIPMENT NECESSARY TO KEEP THE ROADWAYS CLEAN.

- 22. BACKFILL IN ALL STREET CUTS ON ARTERIALS WILL BE CONTROL DENSITY FILL (CDF). CONTRACTOR MUST PROVIDE STEEL PLATING NECESSARY TO ALLOW THE CDF TO CURE.
- 23. WHEN CONSTRUCTING NEW CURB AND GUTTER WHICH DOES NOT ALIGN WITH THE EXISTING EDGE OF PAVEMENT, THE ROADWAY MUST BE TAPERED FROM THE ENDS OF THE NEW CURB AND GUTTER TO MATCH THE EXISTING PAVEMENT. THE ENTRY TAPER INTO THE NEW IMPROVEMENTS SHALL BE 5:1 AND LEAVING THE NEW IMPROVEMENTS SHALL BE 10:1.
- 24. WHEN AN EXISTING ROADWAY IS TO BE WIDENED, THE EXISTING PAVEMENT MUST BE SAW CUT AT LEAST ONE FOOT FROM THE EDGE TO PROVIDE A PROPER MATCH BETWEEN NEW AND EXISTING ASPHALT, HOWEVER, WHEN THE EXISTING PAVEMENT CONTAINS ALLIGATORED AREAS. THOSE AREAS MUST BE REMOVED PRIOR TO WIDENING. ALL SAW CUTS SHALL BE PARALLEL OR PERPENDICULAR TO THE RIGHT-OF-WAY CENTERLINE.
- 25. ALL ROCKERIES MUST BE CONSTRUCTED IN ACCORDANCE WITH THE MOST CURRENT GUIDELINES OF THE ASSOCIATION.
- 26. SAWCUT PAVEMENT TO BE REMOVED TO STRAIGHT VERTICAL LINES. SIDEWALK PANELS SHALL BE REMOVED TO THE NEAREST SCORE-LINES OR CONSTRUCTION JOINTS. FIELD-VERIFY LOCATION OF SCORE-LINES AND CONSTRUCTION JOINTS.

METRO BUS GENERAL NOTES

- 1. IT IS REQUIRED THAT THE CONSTRUCTION COORDINATOR (CONSTRUCTION.COORD@KINGCOUNTY.GOV) AND TRANSIT ROUTE FACILITIES PLANNER FOR THE AREA BE INVITED TO THE PRE-CONSTRUCTION MEETINGS BETWEEN THE CONTRACTOR(S), CONSTRUCTION MANAGEMENT FIRMS AND THE JURIDICTION BEFORE THE NOTICE TO PROCEED IS ISSUED.
- 2. PRIOR TO CONSTRUCTION OF METRO FOOTINGS AND FACILITIES, PLEASE CONTACT METRO INSPECTORS AND CONSTRUCTION AT BUSSTOPINSPECTIONS@KINGCOUNTY.GOV OR BY PHONE AT 206-263-2381. PLEASE NOTE THAT METRO REQUIRES NOTICE OF AT LEAST THREE WEEKS IN ADVANCE TO SCHEDULE AN INSPECTION. ALL METRO FOOTINGS MUST BE INSPECTED AND APPROVED BY METRO INSPECTORS BEFORE ANY CONCRETE IS POURED.
- AFTER SHELTER FOOTING INSPECTION AND COMPLETED CONSTRUCTION, PLEASE CONTACT PLANSREVIEW@KINGCOUNTY.GOV TO SCHEDULE SHELTER FRAME INSTALLATION AND BUS STOP FLAGPOST INSTALLATION.
- 4. AT LEAST FIVE (5) WORKING DAYS PRIOR TO MOBILIZATION AND CLOSING OF ANY BUS STOP, CONTACT METRO TRANSIT CONSTRUCTION COORDINATOR AT (206)477-1140 TO COORDINATE POSTING RIDER ALERT ABOUT BUS STOP CLOSURE AND ESTABLISHMENT OF INTERIM BUS ZONES.
- WHEN ENCOUNTERING CONSTRUCTION SITES WITH EXISTING TRANSIT FURNITURE SUCH AS SHELTERS, PEDESTRIAN LIGHT POST AND LUMINAIRES, BENCHES, LITTER RECEPTACLES AND BUS STOP SIGNS AND POSTS EXIST, CALL MATT RAWSON (206-263-5681).
- BENCHES, LITTER RECEPTACLES AND BIKE LOOPS: METRO TRANSIT WILL FURNISH, TRANSPORT AND INSTALL THE SITE FURNITURE AT EACH BUS ZONE.
- BUS SHELTERS, RAPIDRIDE TECHNOLOGY PYLONS, AND BLADE MARKERS: METRO TRANSIT WILL PROVIDE, TRANSPORT, AND INSTALL THE FIXTURES/ FURNITURE UPON COMPLETION OF THE SITE WORK, INCLUDING THE POWER CONNECTION FROM THE FOUNDATIONS TO THE FIXTURES/ FURNITURE.
- 8. BUS SIGNS, UNLESS OTHERWISE SPECIFICALLY INDICATED ON THE DRAWINGS, METRO TRANSIT WILL FURNISH AND INSTALL BUS SIGNS AT THE ZONES.
- PER SECTION 810 OF THE ADA STANDARDS FOR TRANSPORTATION FACILITIES, THE CROSS-SLOPE OF A BUS STOP BOARDING AND ALIGHTING AREA SHALL NOT BE STEEPER THAN 1:48 (~2%). THIS STANDARD APPLIES TO ANY NEW OR MODIFIED BUS STOP.

LINESTYLE LEGEND	EXISTING
CUT LINE	
FILL LINE	
ALIGNMENT CENTERLINE	
RIGHT-OF-WAY LINE	
PROPERTY LINE	
TEMPORARY CONSTRUCTION EASEMENT LINE	
PERMANENT UTILITY EASEMENT LINE	
CABLE TV LOCATES	TV
COMMUNICATION LOCATES	T
FIBER OPTIC LOCATES	—F0 —F0 —F0 —_
GAS LOCATES	G
STORM LINE	SD
SEWER LINE	SS
POWER LOCATES	P
WATER LOCATES	W
EDGE OF ASPHALT	

ABBRE	EVIATIONS
AP	ANGLE POINT
AVE	AVENUE
CB	CATCH BASIN
CL	CENTERLINE
COMM	COMMUNICATION
CONC	CONCRETE
DB	DIRECT BURY
DET	DETECTION
DI	DUCTILE IRON
DNF	DID NOT FIND
EL	ELEVATION
EVP	EMERGENCY VEHICLE PRE-EMPTION
EX	EXISTING
FT	FEET
GPS	GLOBAL POSITIONING SYSTEM
HMA	HOT MIX ASPHALT
IE.	INVERT ELEVATION
IN . –	INCH
LF	LINEAR FEET
LT	LEFT
MIN	MINIMUM
MON	MONUMENT
NE	NORTHEAST
NO	NUMBER
NST	NO STEEPER THAN
PED	PEDESTRIAN
PPB	PEDESTRIAN PUSH BUTTON
PVI	POINT OF VERTICAL INTERSECTION
RCP	REINFORCED CONCRETE PIPE
ROW	RIGHT-OF-WAY
RT	RIGHT
SMFO	SINGLE MODE FIBER OPTIC
ST	STREET
STA	STATION
STW	WRAPPED STEEL
VAR	VARIES
VC	VERTICAL CURVE
VEH	VEHICLE
WA	WASHINGTON
WAC	WASHINGTON ADMINISTRATIVE CODE

OT WIDOL LEGEND	<u>LXIOTINO</u>	I KOI OOLI
FOUND SURFACE MONUMENT	•	
FOUND MAG NAIL	-	
FOUND REBAR AND CAP	lacktriangle	
SIGN	þ	•
TRAFFIC SIGNAL POLE		
TRAFFIC SIGNAL POLE WITH LIGHT		
GAS VALVE	\Box	
CATCH BASIN		
CATCH BASIN SOLID	\boxtimes	
STORM CLEAN OUT	⊚	
MANHOLE		
STORM SEWER CLEAN OUT	⊚	
MANHOLE SEWER		
POWER	P	
JUNCTION BOX POWER PANEL	P	
POWER TRANSFORMER		
TELEPHONE RISER	TR	
TELEPHONE MANHOLE	T	
TELEPHONE PANEL	Т	
UNKNOWN UTILITY VAULT	U	
GATE POST	0	
MONITORING WELL	•	
FIRE DEPT CON	C	
IRRIGATION VALVE		
FIRE HYDRANT	Q	
WATER METER		
WATER VALVE	\bowtie	H
LIGHT	- \ \-	
STANDARD STREET LIGHT		+
POWER POLE	-0-	
GUARD POST	0	

EXISTING

PROPOSED

SYMBOL LEGEND

ENGINEERING. PLANNING. ENVIRONMENTAL SCIENCES

GENERAL NOTES, LEGEND, AND **ABBREVIATIONS**

> NE 124TH ST / 116TH AVE NE INTERSECTION IMPROVEMENTS CITY OF KIRKLAND. WA

BID SET

CITY OF KIRKLAND

DEPARTMENT OF PUBLIC WORKS 123 FIFTH AVENUE KIRKLAND, WA 98033

(425) 587-3800 www.kirklandwa.gov

BY APPR. NO. DATE **REVISION**

APPROVED BY:

DATE: 10/5/2021


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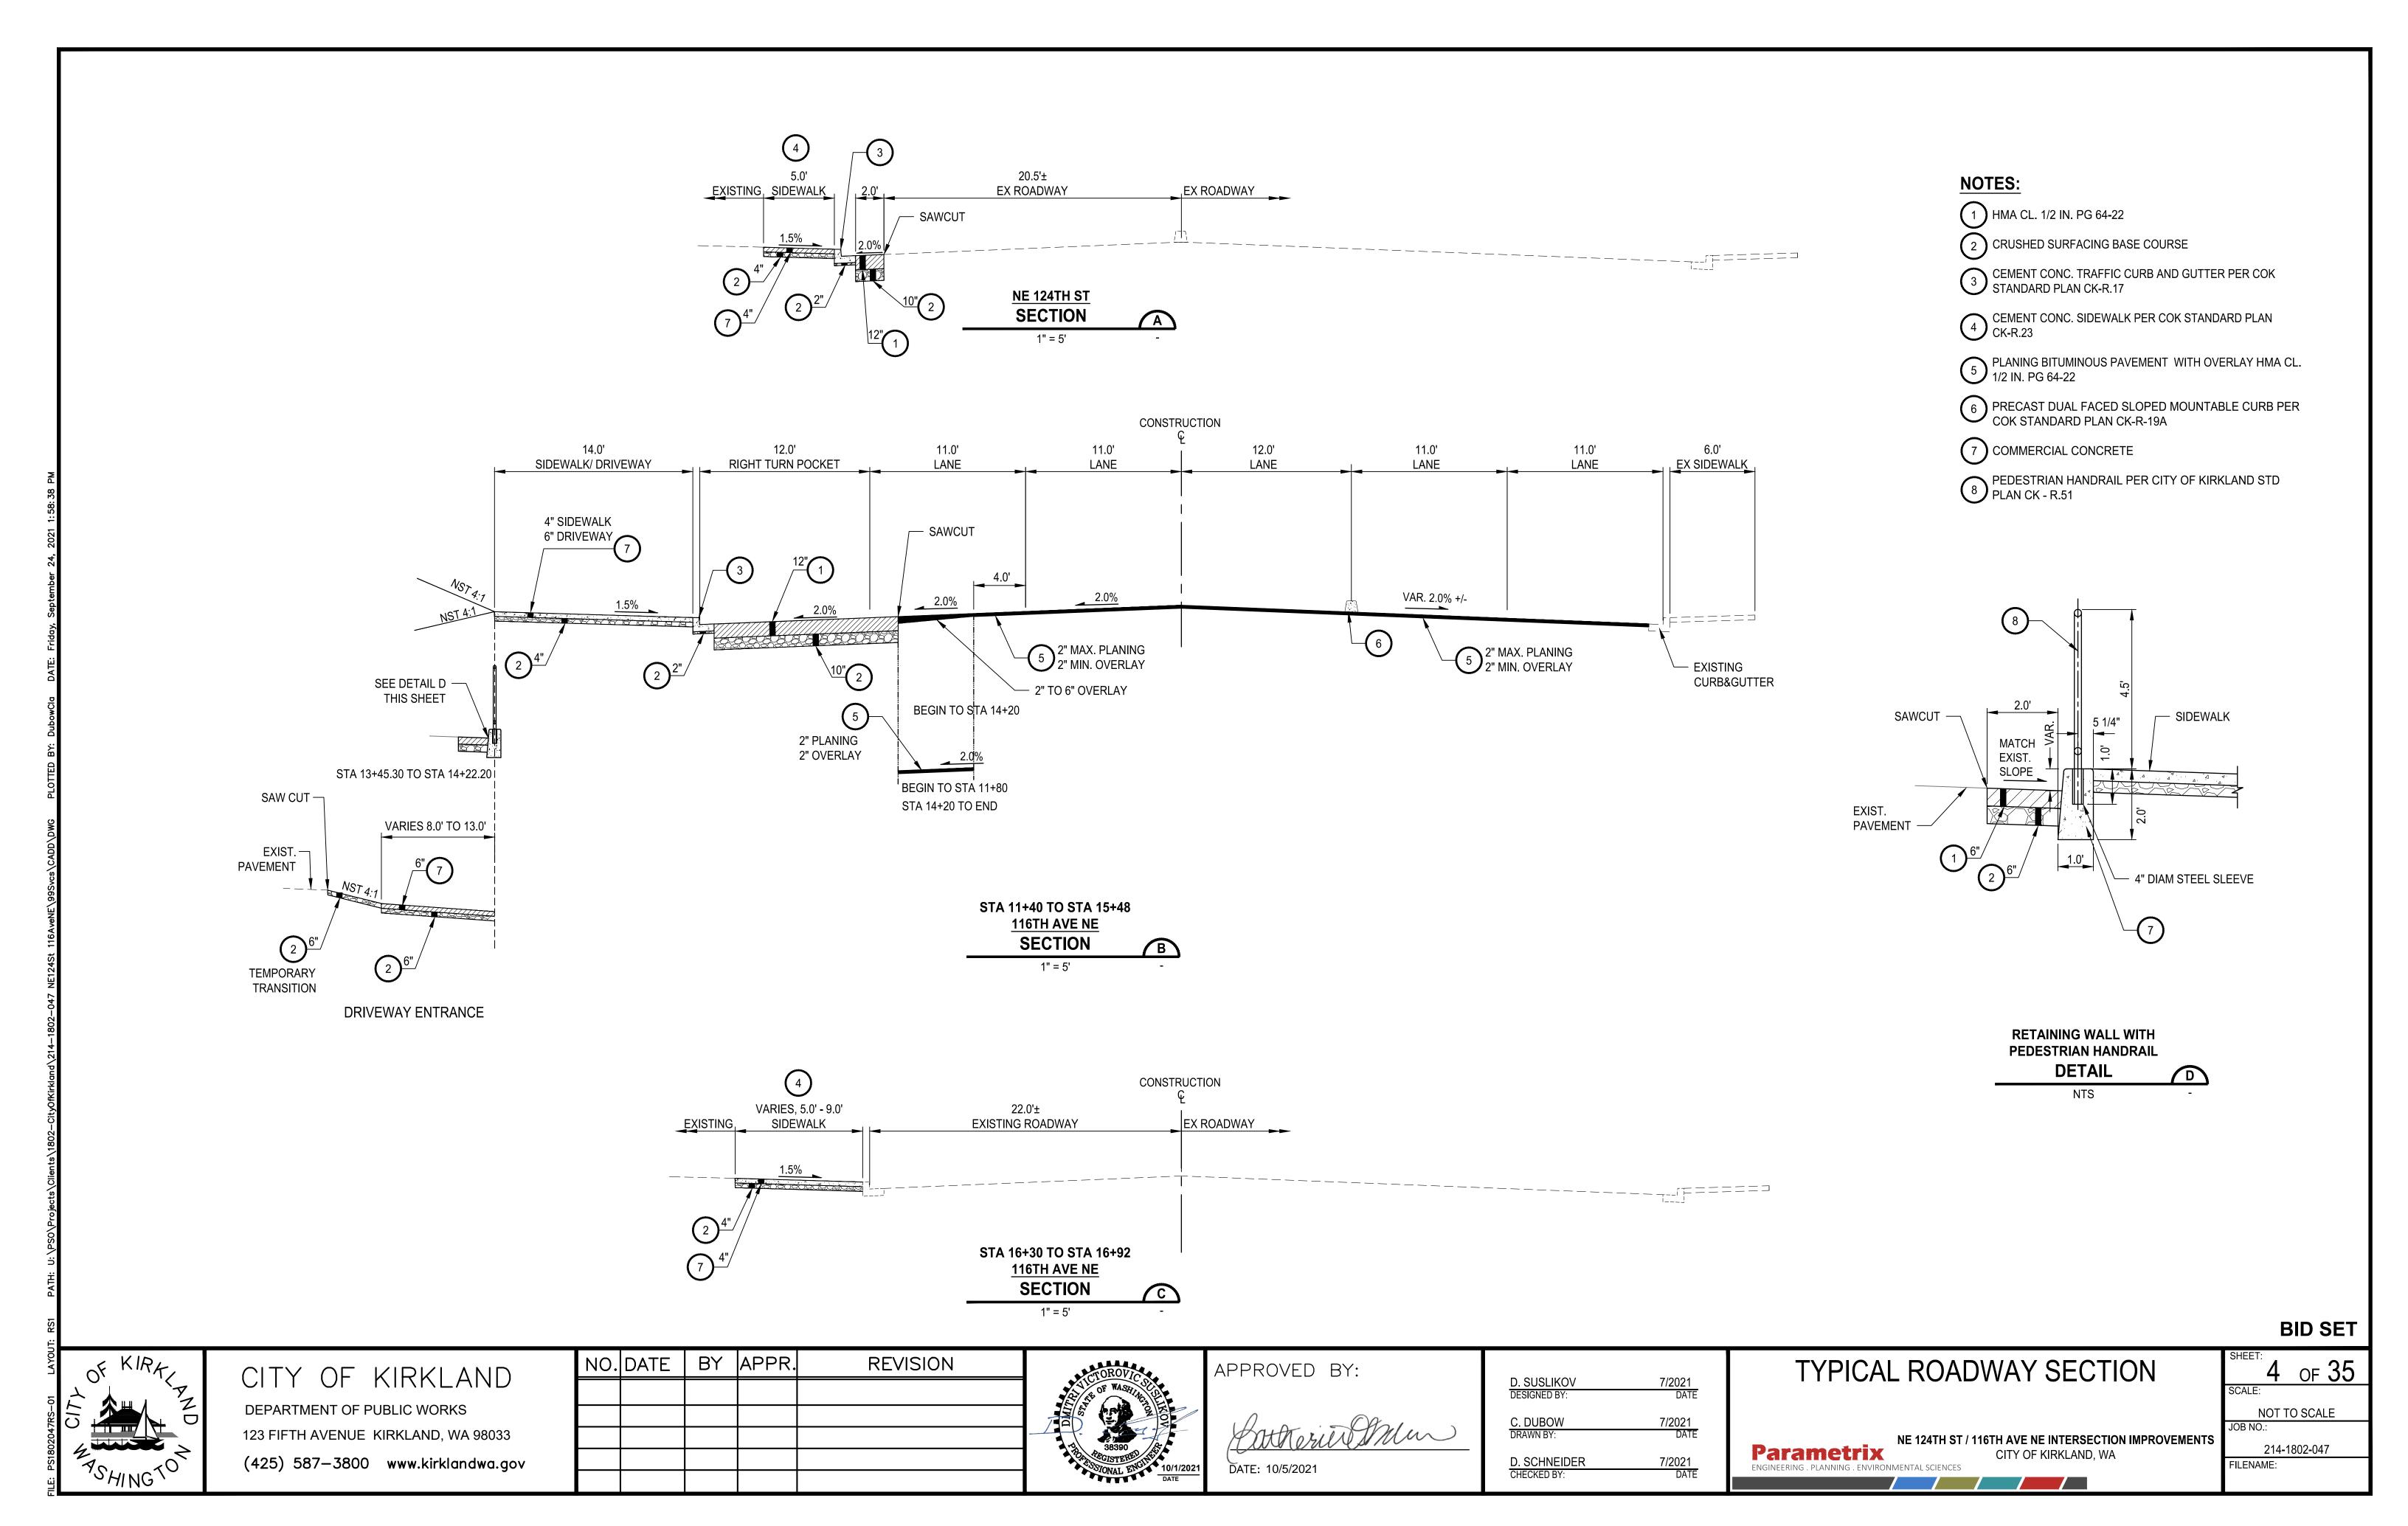
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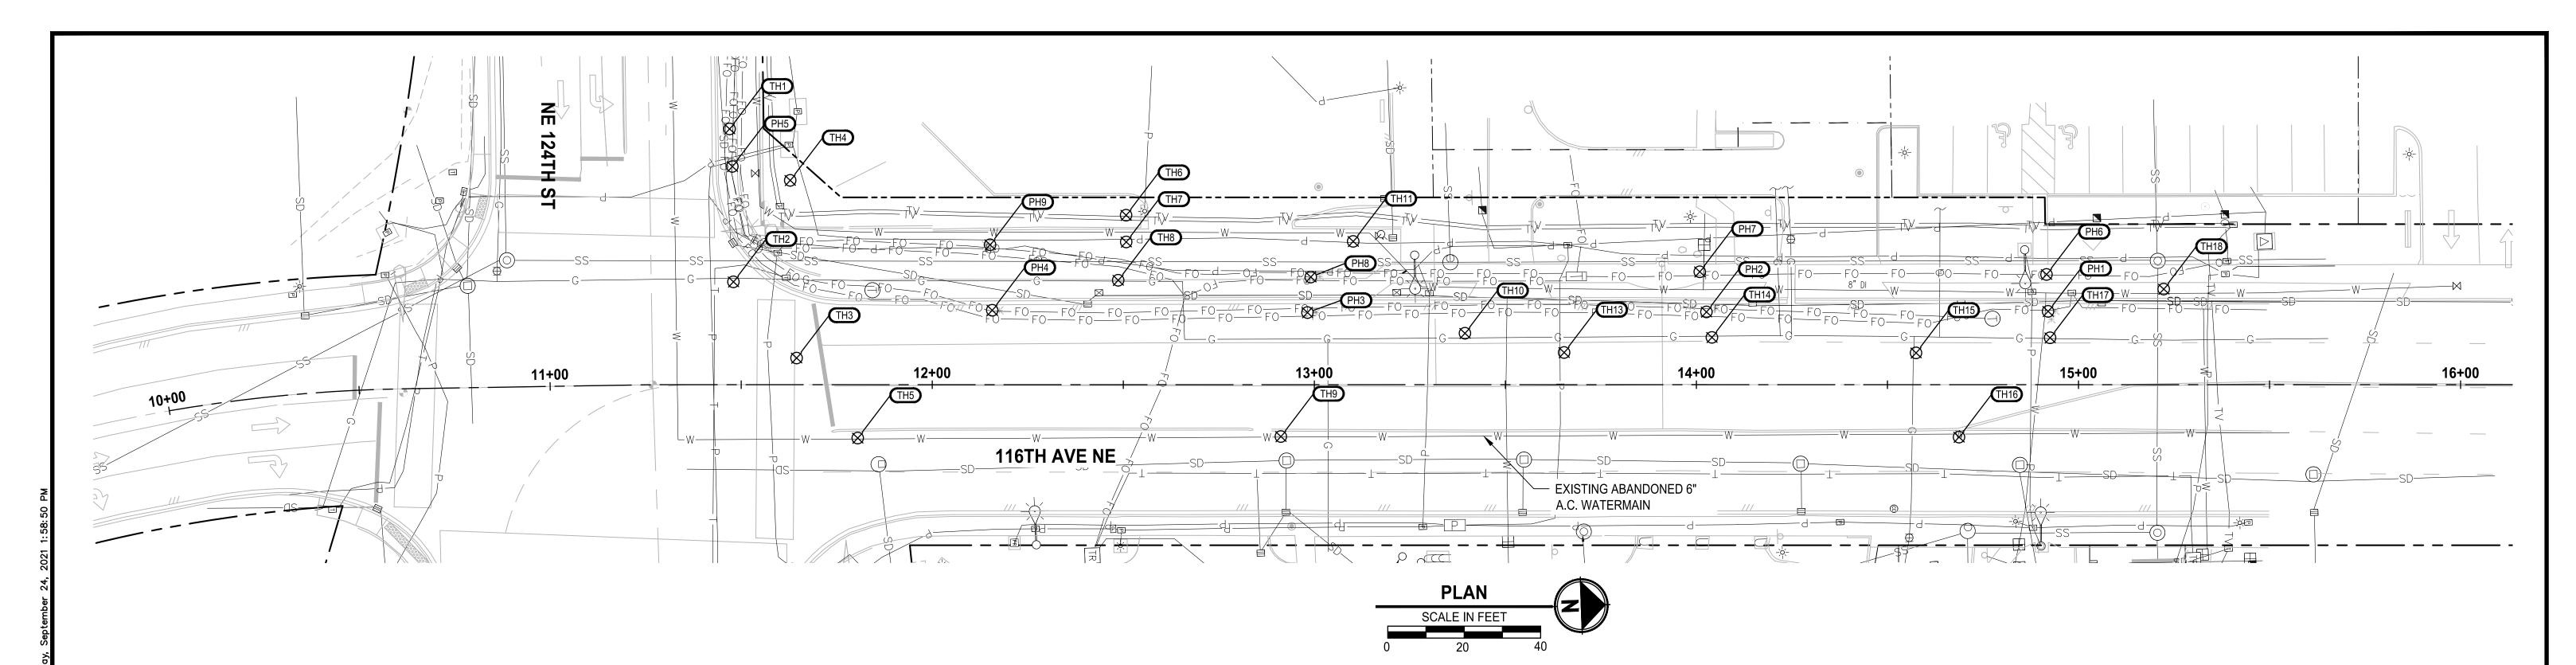
D. SUSLIKOV 7/2021 7/2021 DATE C. DUBOW D. SCHNEIDER 7/2021 CHECKED BY:

Parametrix

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								LEGEND		
POTHOLE	STATION	OFFSET	UTILITY TYPE	UTILITY MATERIAL	UTILITY SIZE	TOP OF UTILITY FROM GRADE	BOTTOM OF UTILITY FROM GRADE	PAVEMENT DEPTH	COMMENTS	THX 202
TH1	11+47.0	66.9' LT	COMMUNICATION	CDF	60"	8"	28"	8" AND 6"	FOUND CDF DUCT BANK, COULD NOT LOCATE OTHER UTILITES AROUND IT. 7' SLOT CUT.	PHX) 20°
TH2	11+48.0	26.9' LT	GAS	MPE	4"	41"	45"	14"		
TH3	11+64.5	7.0' LT	POWER	DNF	DNF	DNF	DNF	26"	ASPHALT TOO THICK TO JACKHAMMER ALL THE WAY THROUGH.	
TH4	11+62.8	53.5' LT	CLEAR	CLEAR	CLEAR	CLEAR	CLEAR	-	CLEARED DOWN TO 7', DID NOT LOCATE ANY UTILITIES.	
ГН5	11+80.5	14.0' RT	WATER	AC	8"	68"	76"	28"	TOP TAPPED FOR MEASUREMENT DUE TO TOO MUCH GROUND WATER.	
ГН6	12+50.7	44.3' LT	COMMUNICATION	DB	2"	55"	57"	-		
ГН7	12+50.8	37.3' LT	POWER	PVC	2"x4"	31"	35"	3"		
ГН8	12+48.7	27.3' LT	GAS	STW	4"	44"	48"	9"		
ГН9	12+91.2	13.6' RT	WATER	AC	8"	52"	60"	10"		
H10	13+39.4	13.5' LT	GAS	STW	4"	39"	43"	10"		
H11	13+10.2	37.5' LT	POWER	PVC	2"X4"	28"	32"	3"		
H12	NOT FOUND	NOT FOUND	POWER	DNF	DNF	DNF	DNF	-	DID NOT DIG, COULD NOT GET A GOOD LOCATE ON THE POWER.	
H13	13+65.4	8.4' LT	POWER	DNF	DNF	DNF	DNF	12	DUG ON LOCATE AND COULD NOT DIG PAST 4'.	
H14	14+04.1	12.4' LT	GAS	STW	4"	49"	53"	9"		
H15	14+57.5	8.3' LT	GAS	STW	2"	43"	45"	12"		
H16	14+68.7	13.7' RT	WATER	AC	8"	50"	58"	12"		
H17	14+92.6	12.3' LT	GAS	STW	4"	42"	46"	7"		
H18	15+22.3	25.0' LT	WATER	DI	8"	47"	55"	-	PIPE LOOKS TO BE WRAPPED IN PLASTIC.	
H1	14+92.0	19.2' LT	COMMUNICATION	PVC	3"x2"	40"	42"	8"	FOUND 2" UNKNOWN UTILITY. NO LOCATES FOR UNKNOWN.	
H2	14+02.6	19.0' LT	COMMUNICATION	DNF	DNF	DNF	DNF	8	HIT FLOWING GROUND WATER AT 3'. PROBED TO 6' ON LOCATE, NO FEELING OF ANY UTILITY. UNABLE TO GET GOOD LOCATE.	
PH3	12+98.2	18.9' LT	COMMUNICATION	RUBBER	16"	67"	83"	6"		
PH4	12+15.7	19.5' LT	COMMUNICATION	RUBBER	16"	71"	87"	8"		
PH5	11+47.7	57.1' LT	COMMUNICATION	DNF	DNF	DNF	DNF	4"	CDF UNDER SIDEWALK, UNABLE TO GO THROUGH. BOTHER FIBER LINES APPEAR TO COME TOGETHER. RING CLAMPED UTILITY LOCATED TO CENTER OF SIDEWALK. GOT DEPTH OF 5'-8".	
PH6	14+91.6	28.9' LT	COMMUNICATION	PVC	2"x4"	28"	32"	4"		
H7	14+00.9	29.4' LT	COMMUNICATION	PVC	2"x4"	48"	52"	4"		
PH8	12+99.1	28.2' LT	COMMUNICATION	PVC	3"x4"	46"	50"	4"		
PH9	12+15.2	36.6' LT	COMMUNICATION	PVC	3"x4"	30"	34"	4"		

BID SET

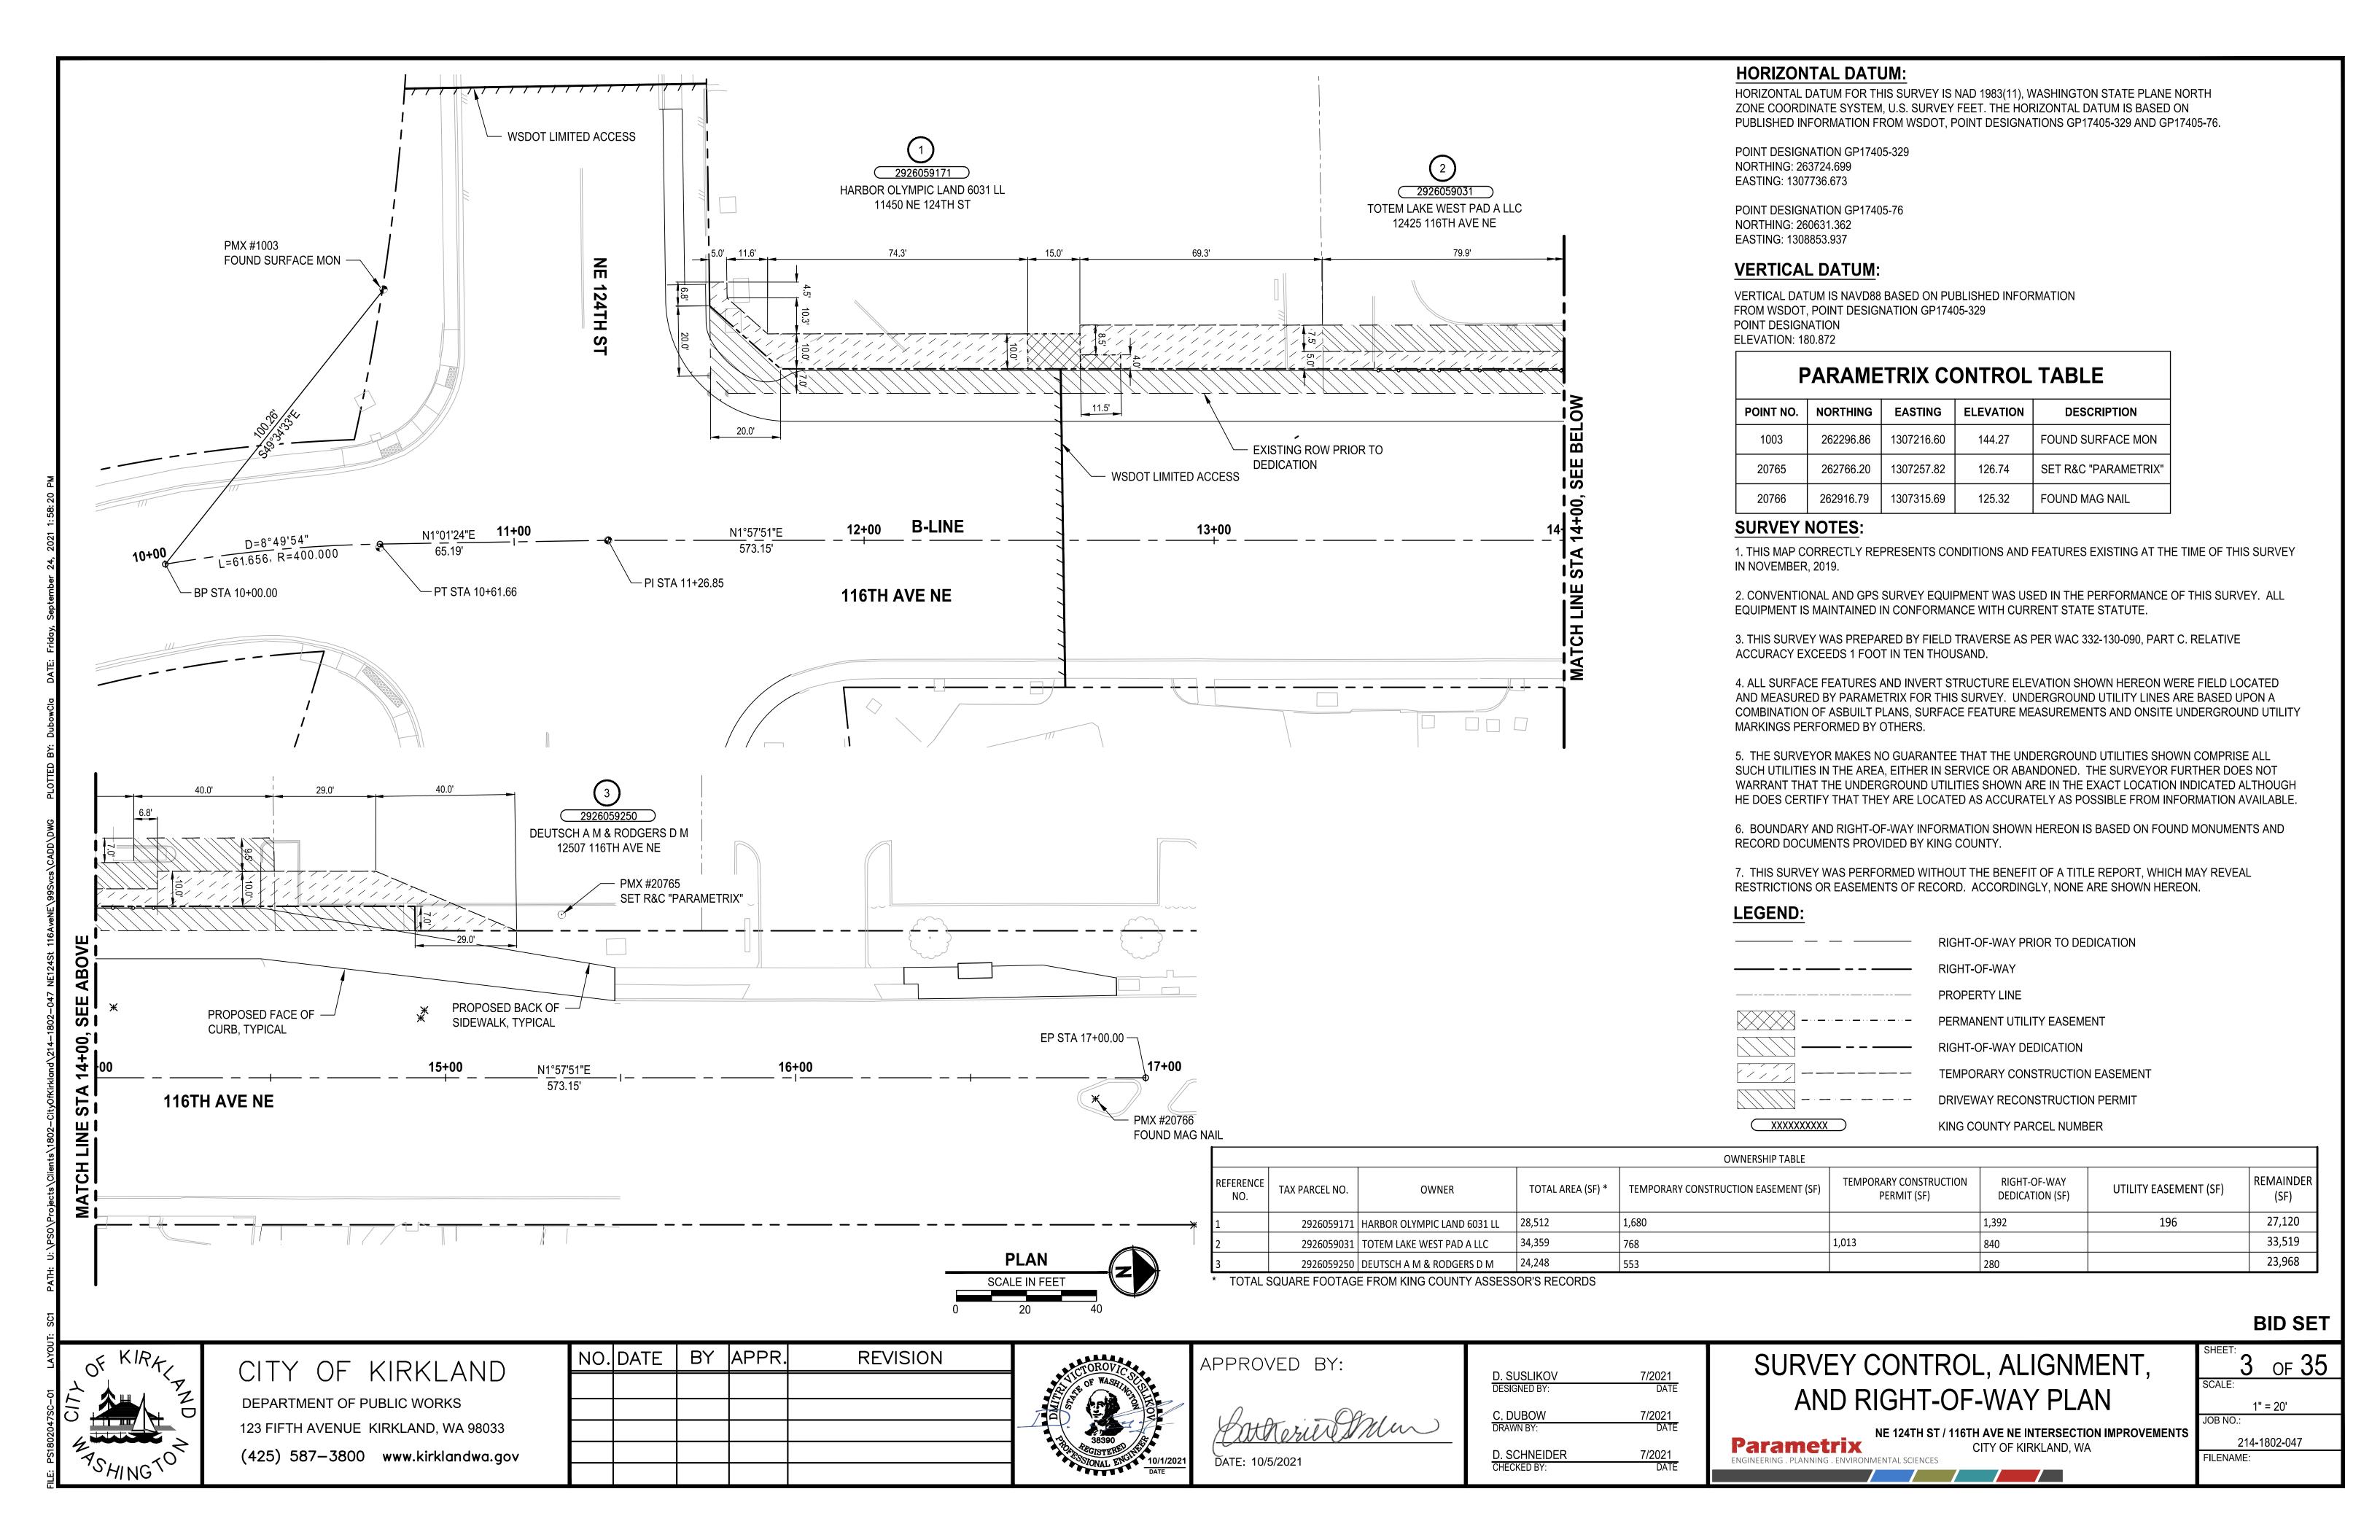

CITY OF KIRKLAND


DEPARTMENT OF PUBLIC WORKS

123 FIFTH AVENUE KIRKLAND, WA 98033

(425) 587–3800 www.kirklandwa.gov

NO.	DATE	BY	APPR.	REVISION	



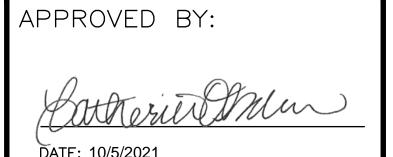

D. SUSLIKOV	7/2021
DESIGNED BY:	DATE
C. DUBOW	7/2021
DRAWN BY:	DATE
D. SCHNEIDER	7/2021
CHECKED BY:	DATE

POTHOLING PLAN AND SCHEDULE

NE 124TH ST / 116TH AVE NE INTERSECTION IMPROVEMENTS
Parametrix CITY OF KIRKLAND, WA
ENGINEERING . PLANNING . ENVIRONMENTAL SCIENCES

SHEET:

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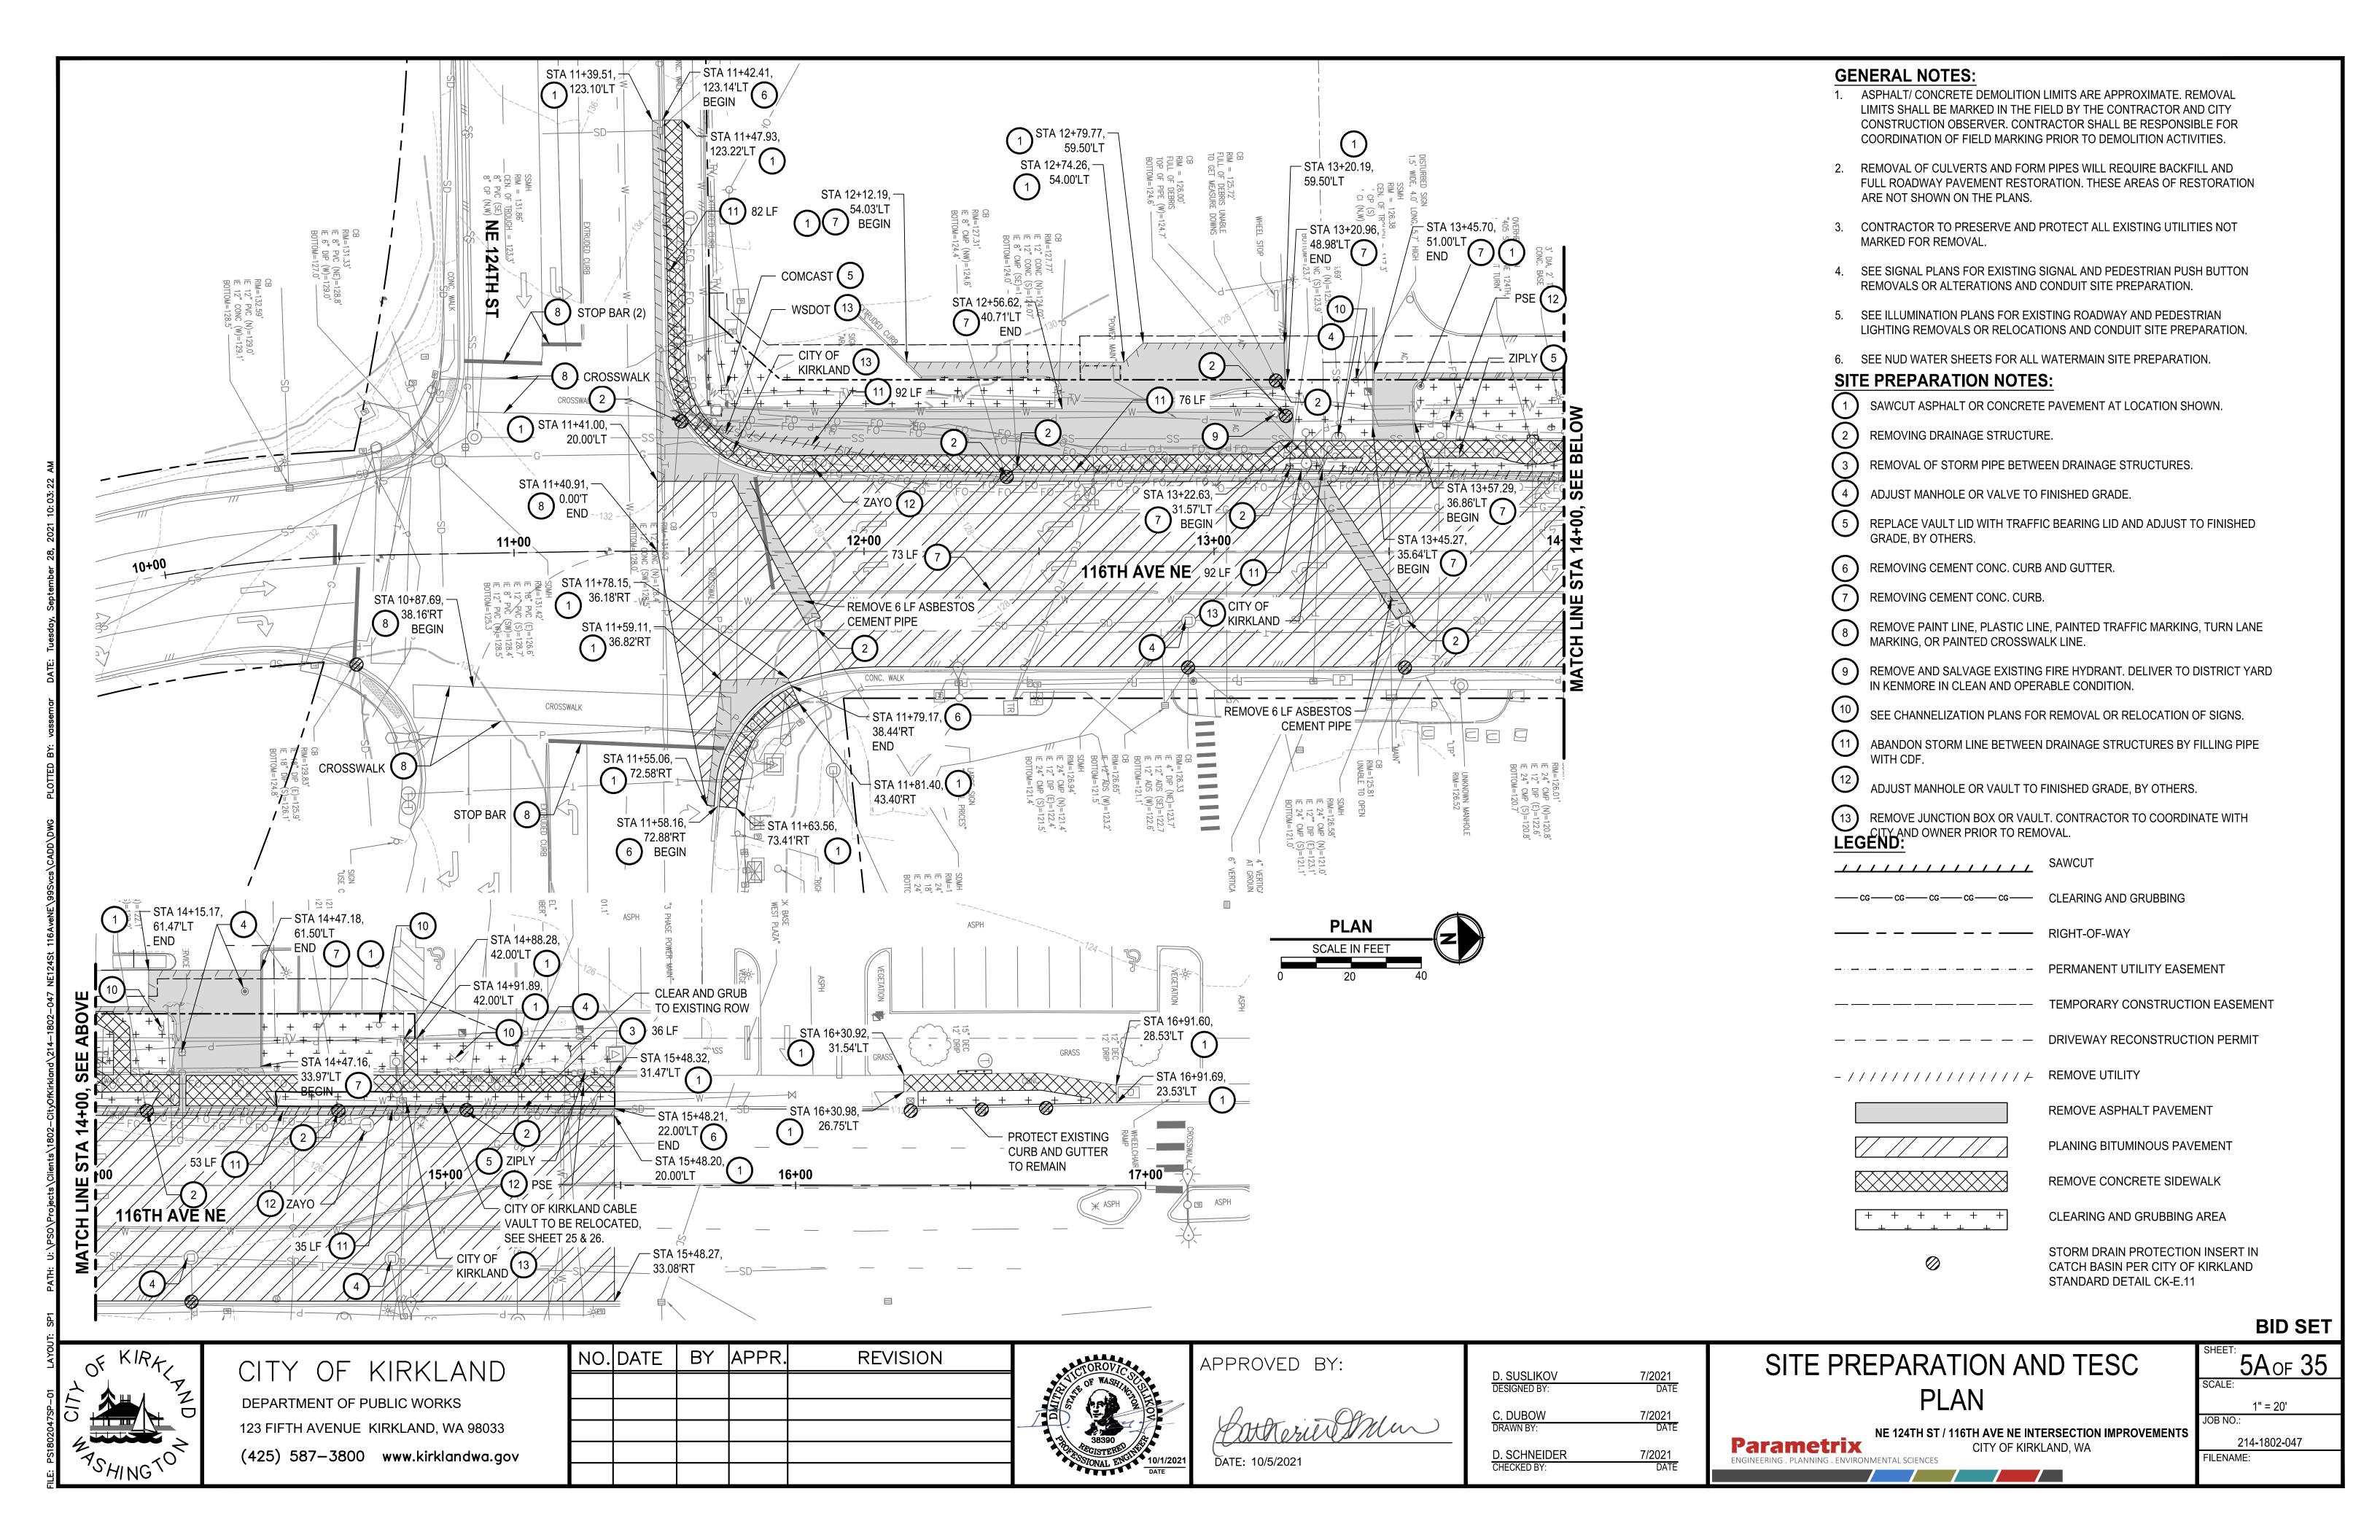
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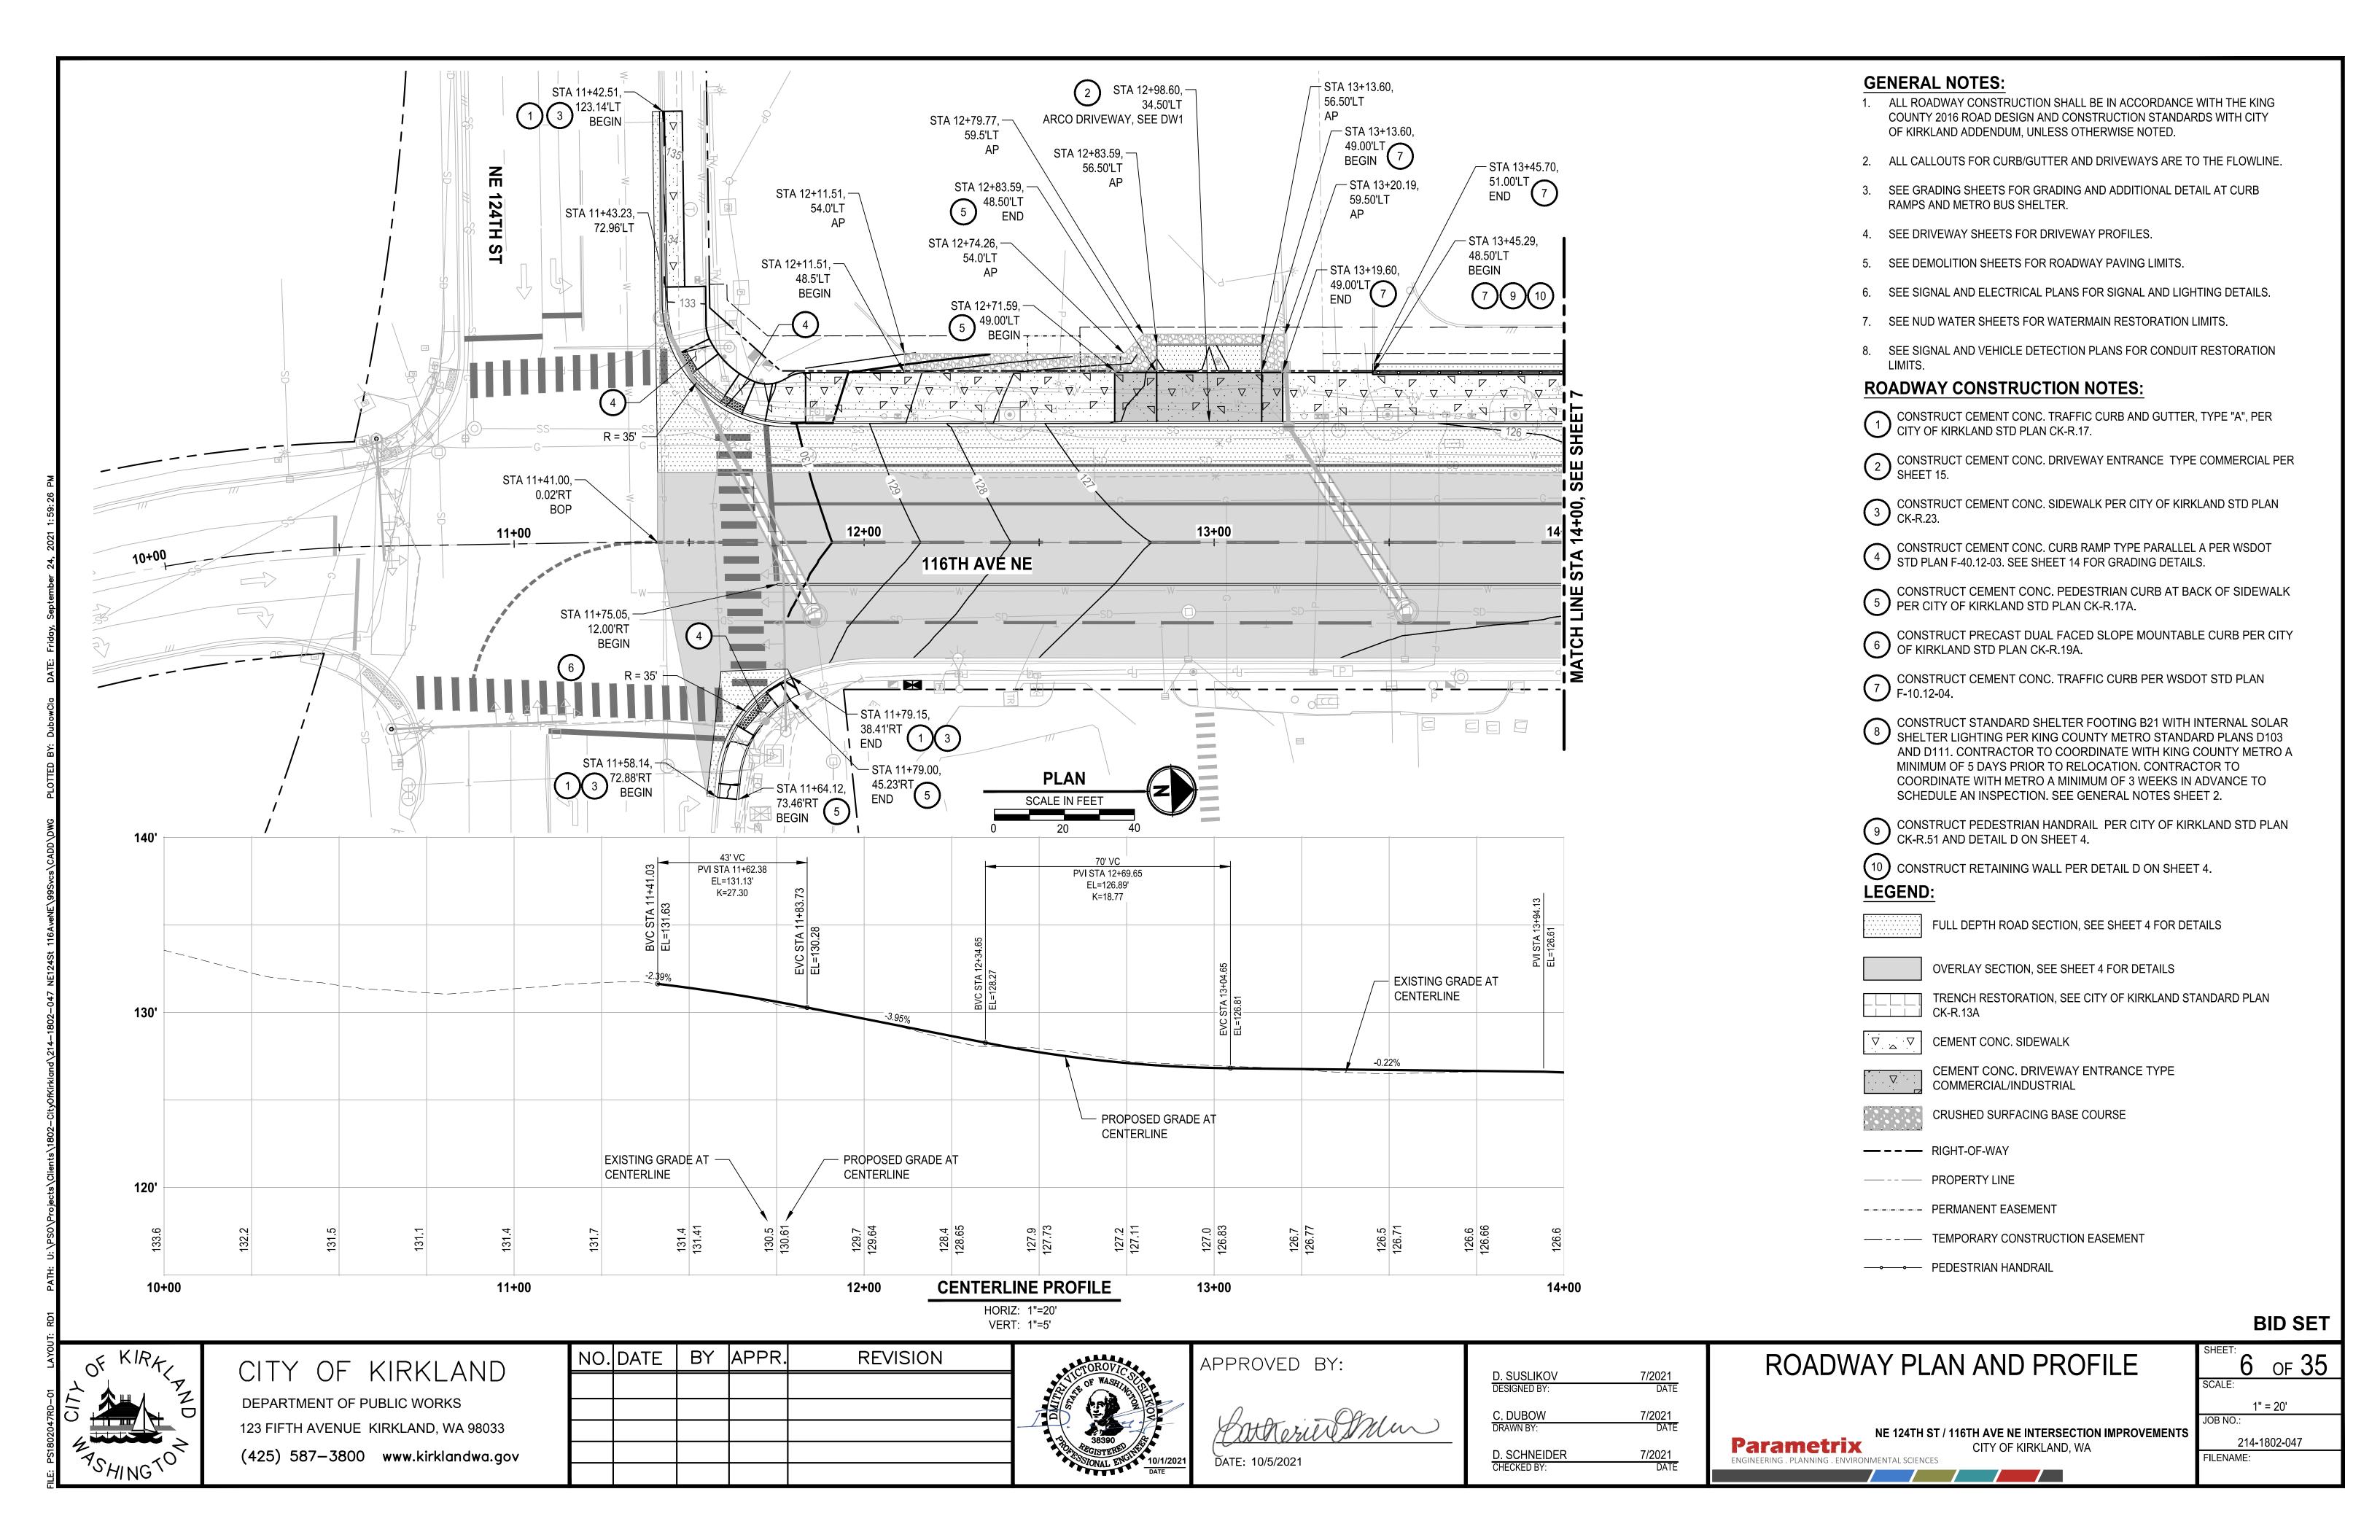
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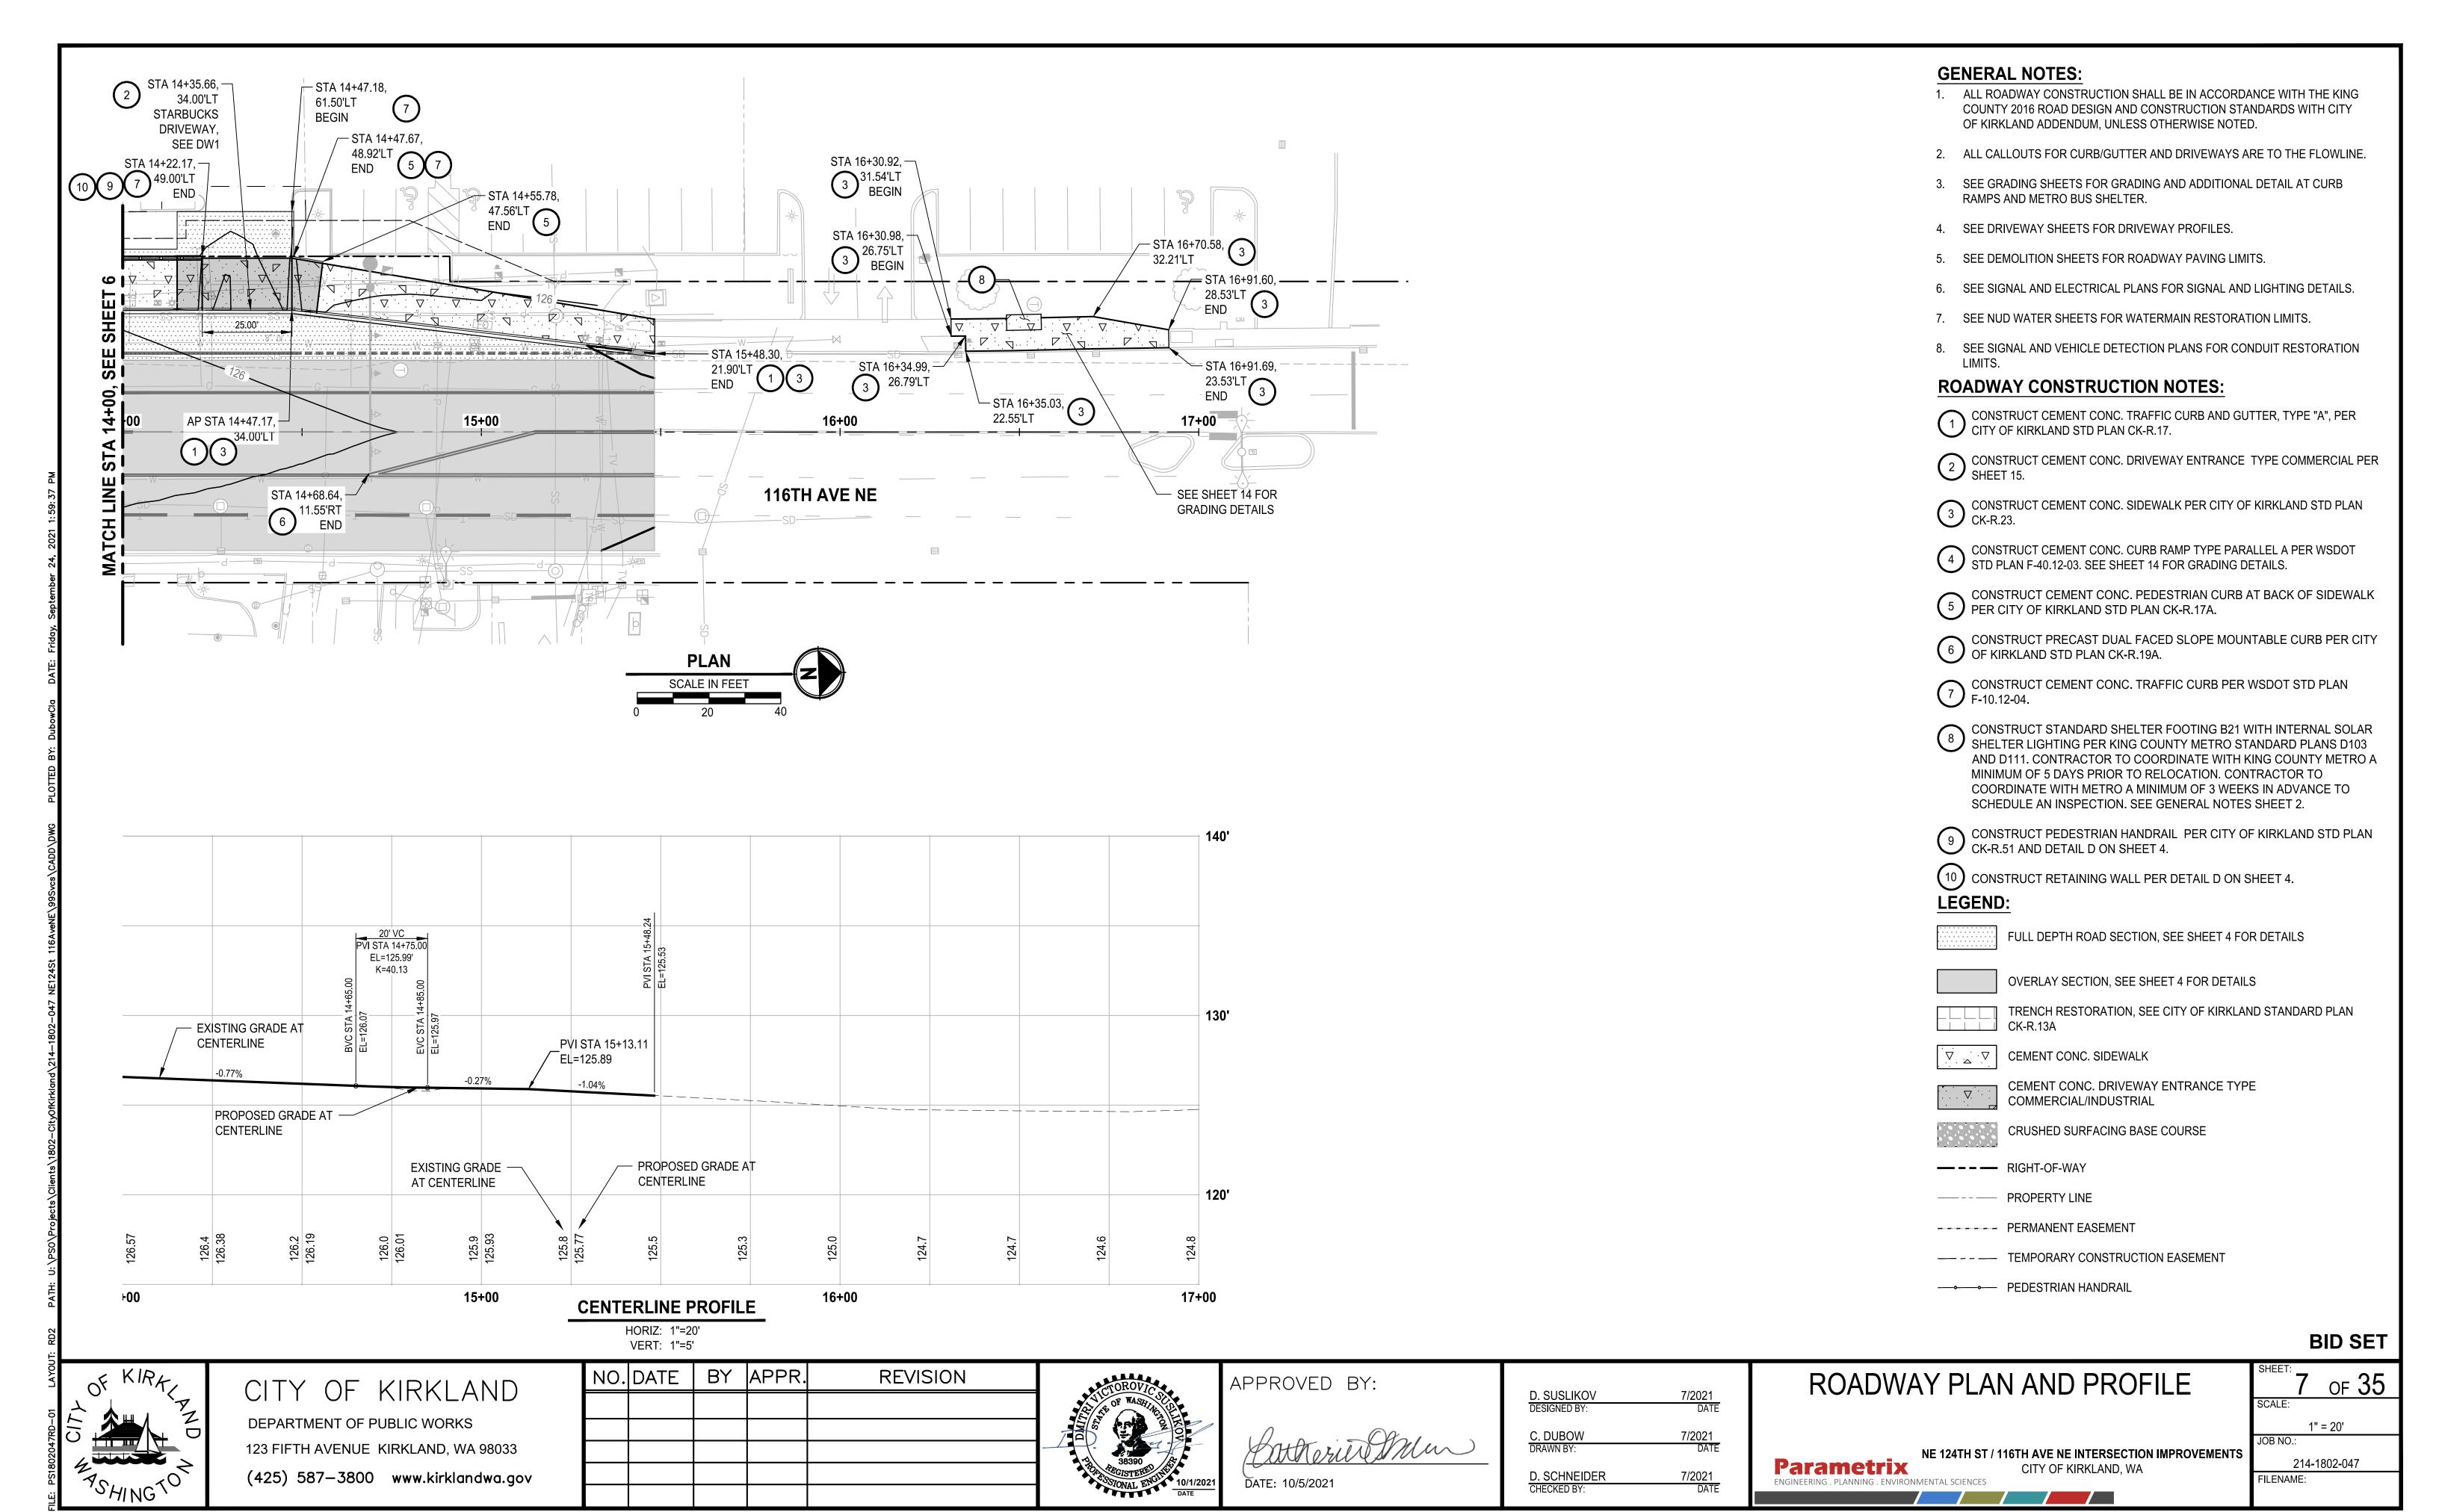
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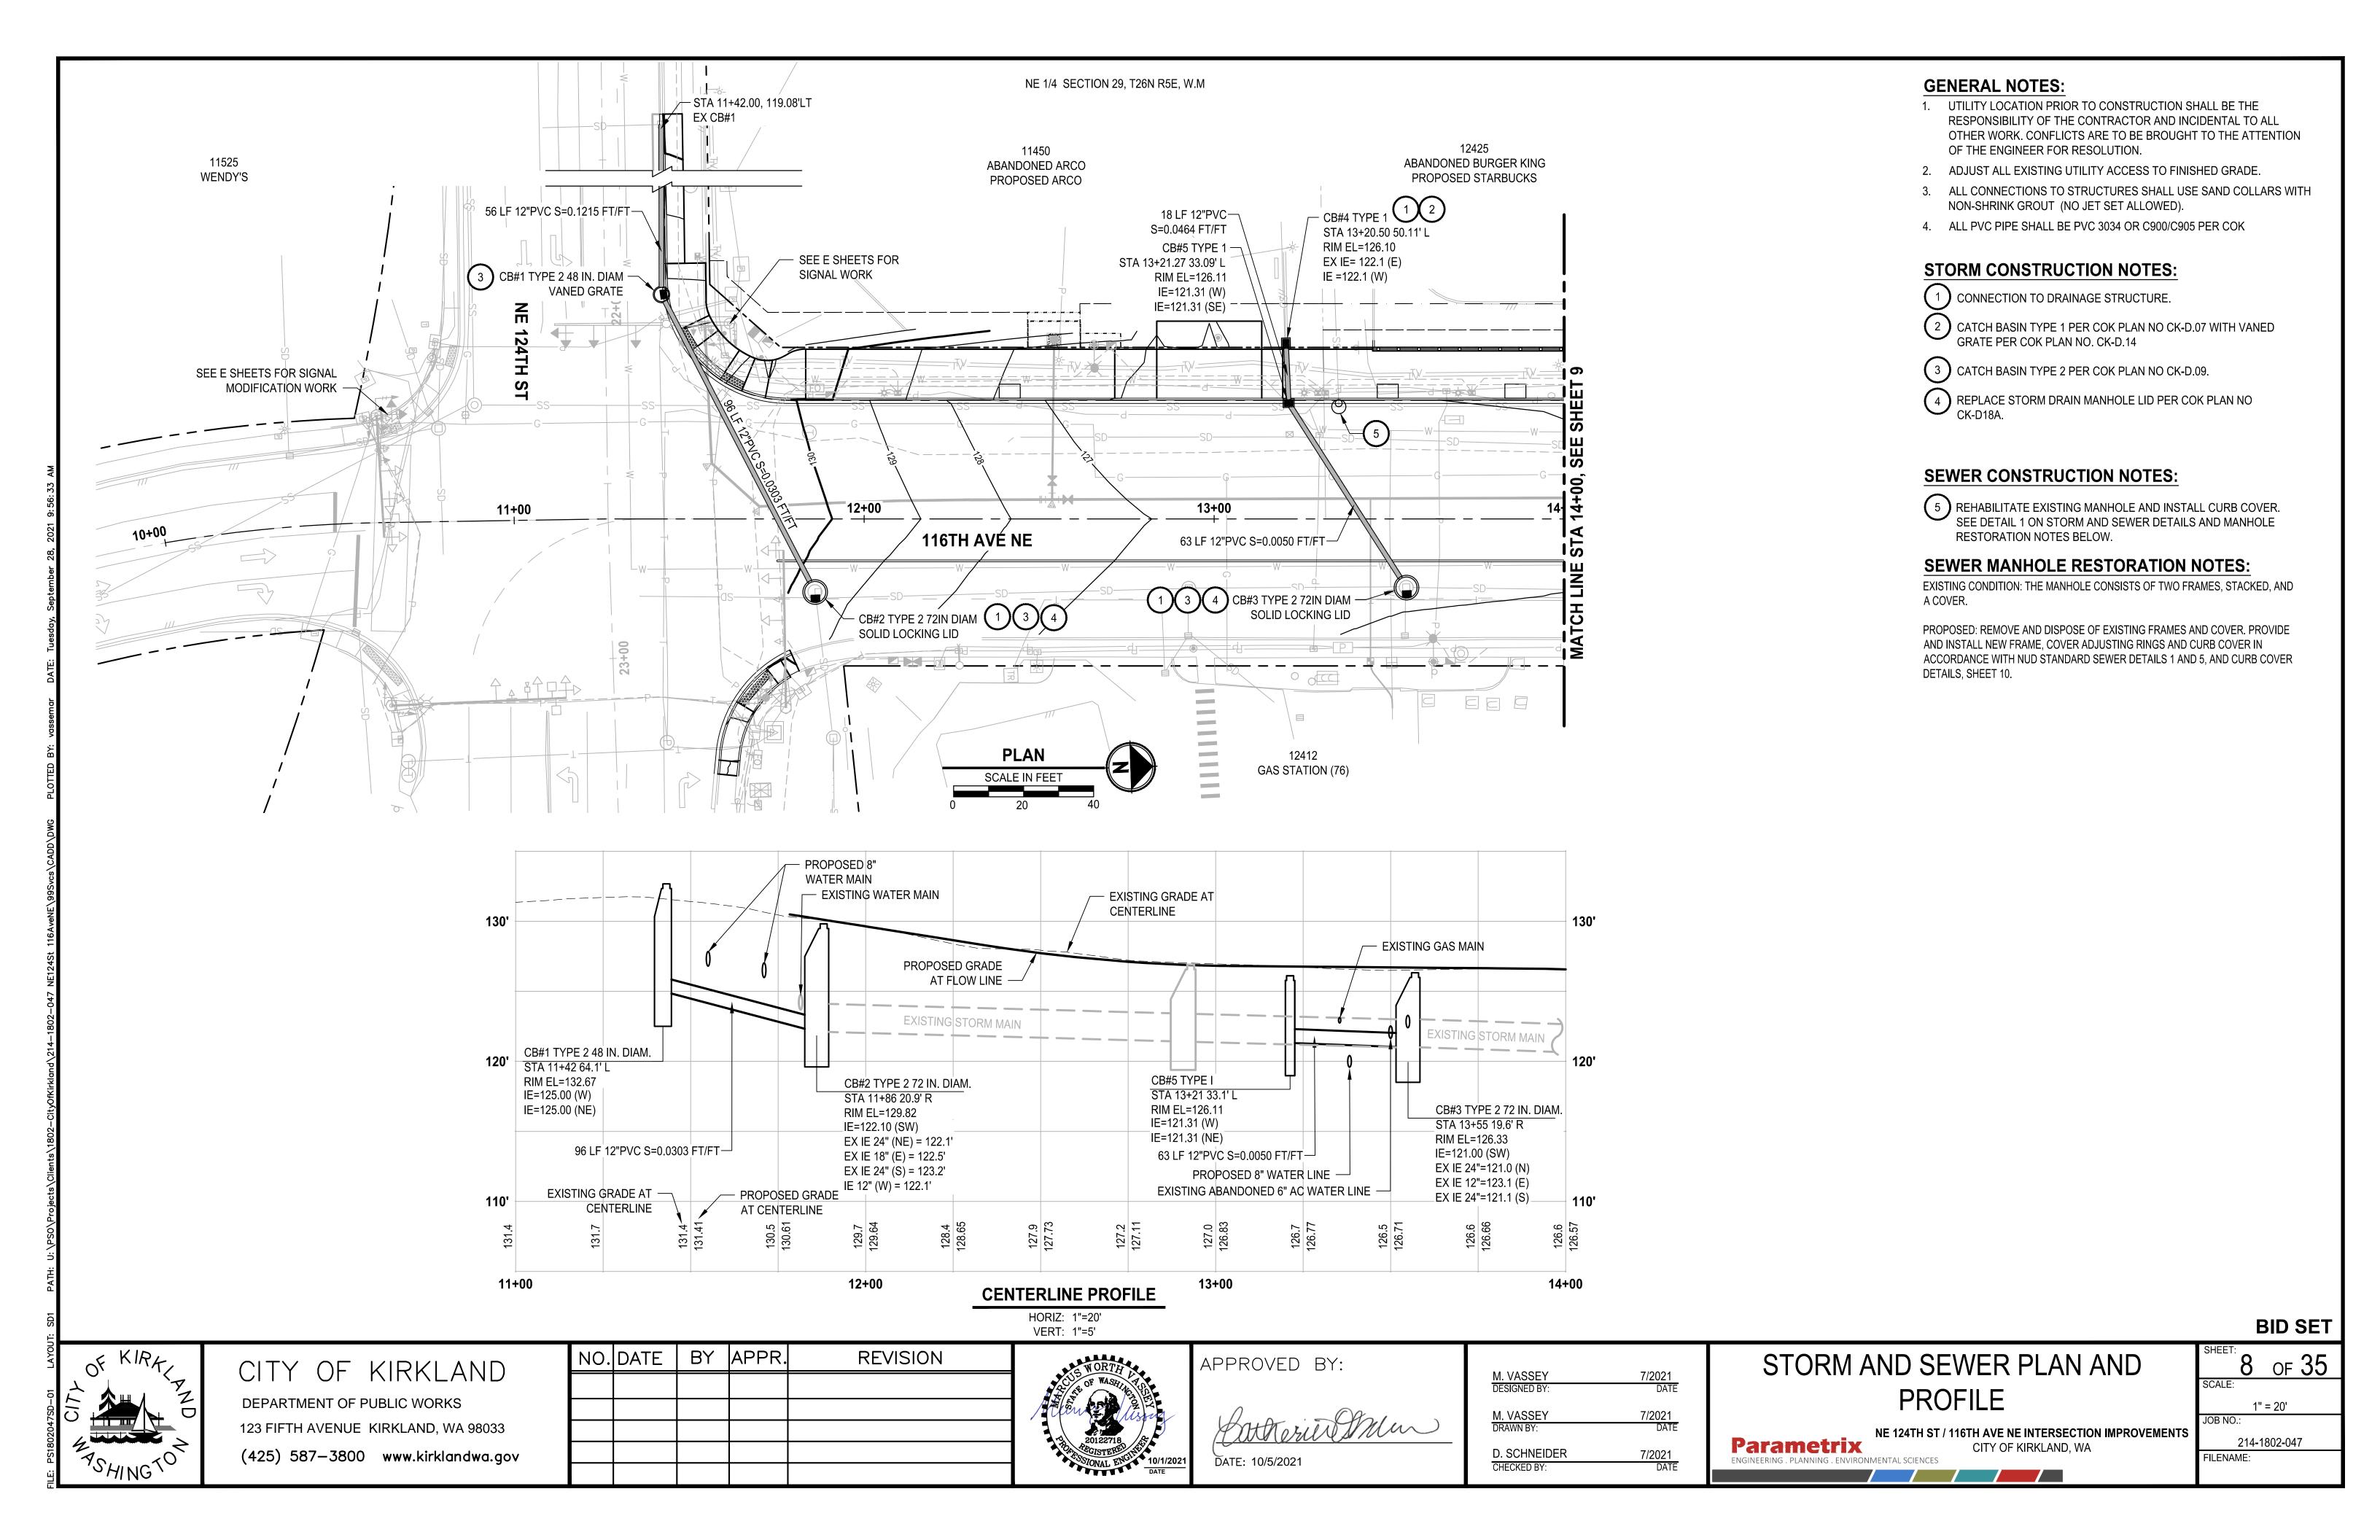
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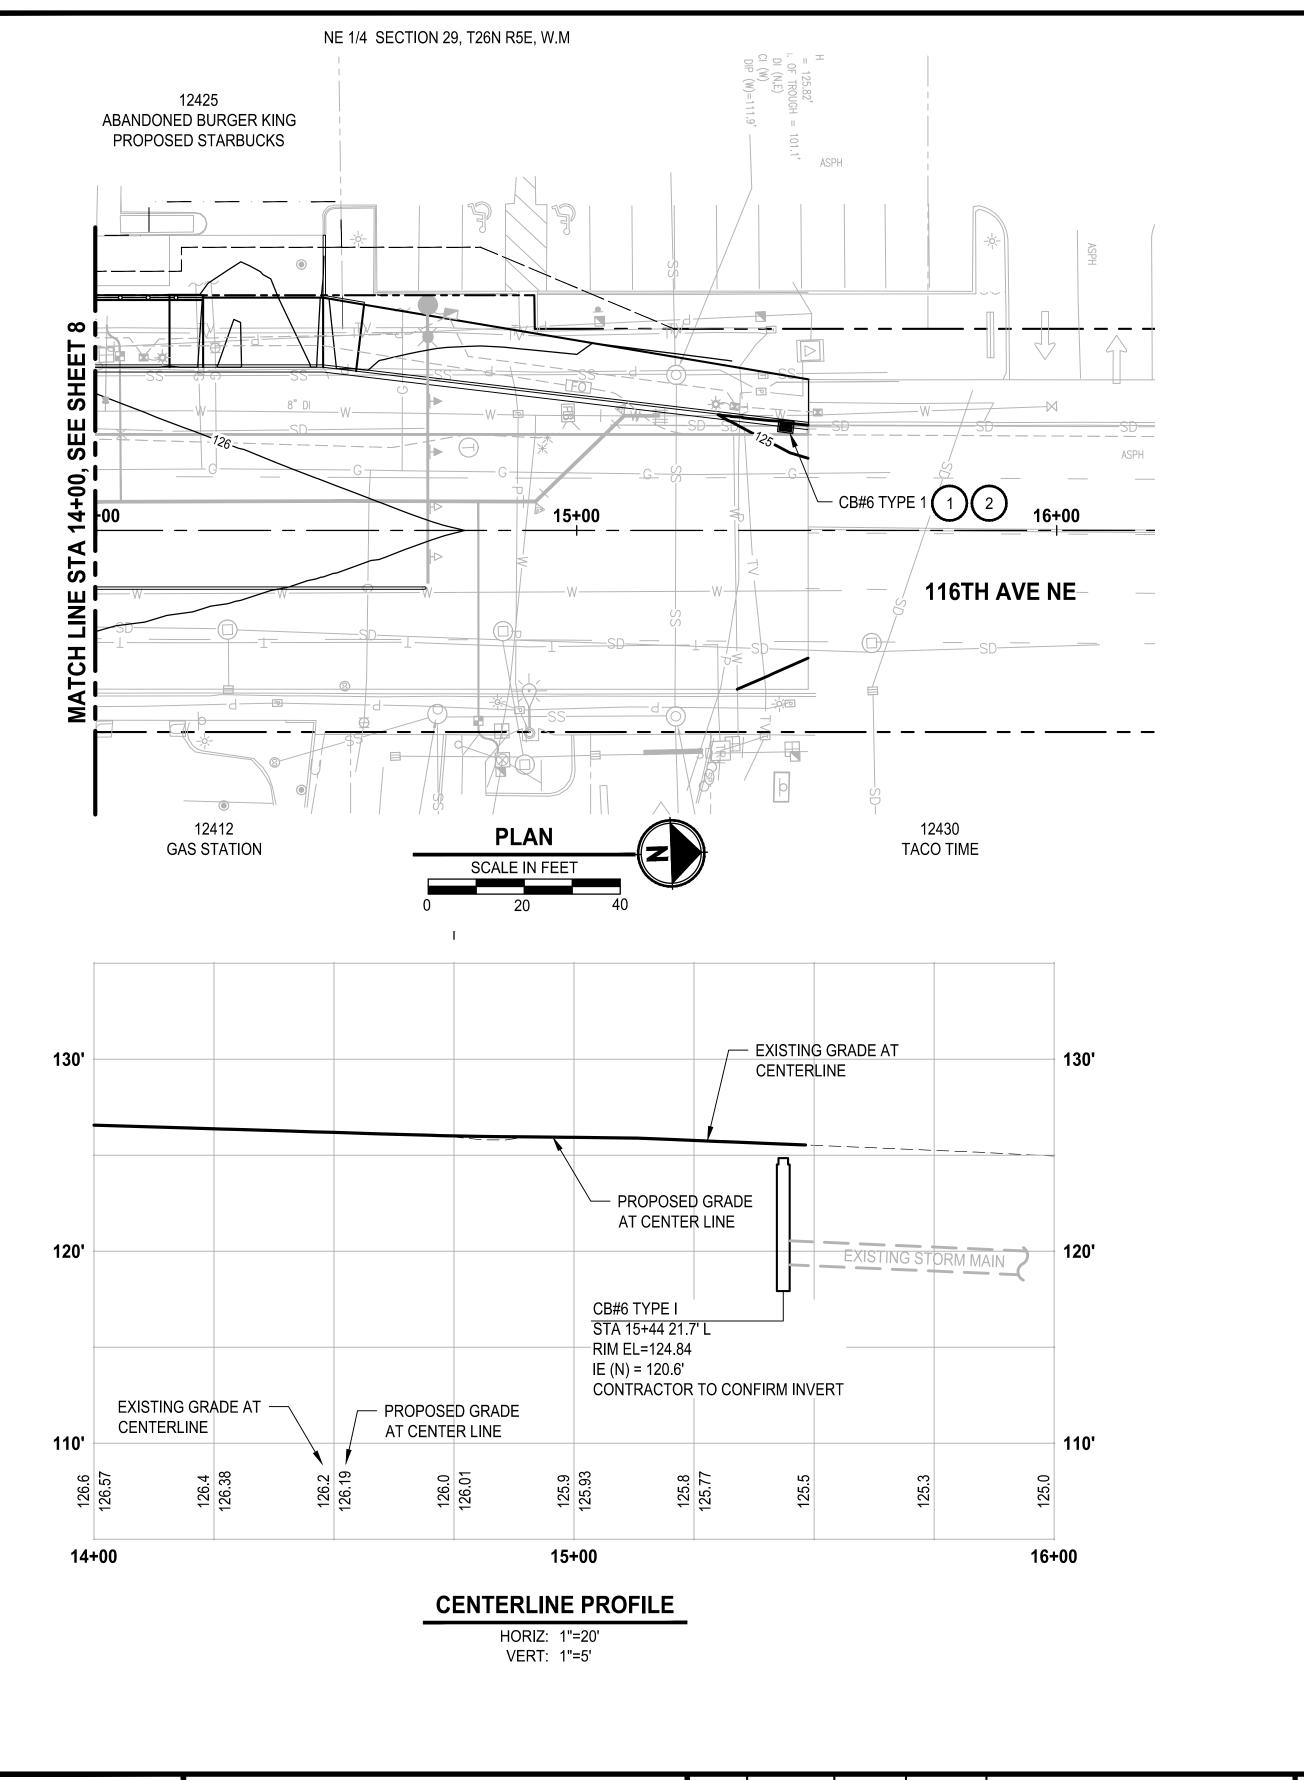
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- 1. UTILITY LOCATION PRIOR TO CONSTRUCTION SHALL BE THE RESPONSIBILITY OF THE CONTRACTOR AND INCIDENTAL TO ALL OTHER WORK. CONFLICTS ARE TO BE BROUGHT TO THE ATTENTION OF THE ENGINEER FOR RESOLUTION.
- 2. ADJUST ALL EXISTING UTILITY ACCESS TO FINISHED GRADE.
- 3. ALL CONNECTIONS TO STRUCTURES SHALL USE SAND COLLARS WITH NON-SHRINK GROUT (NO JET SET ALLOWED).
- 4. ALL PVC PIPE SHALL BE PVC 3034 OR C900/C905 PER COK

STORM CONSTRUCTION NOTES:

(1) CONNECTION TO DRAINAGE STRUCTURE.

2 CATCH BASIN TYPE 1 PER COK PLAN NO CK-D.07 WITH VANED GRATE PER COK PLAN NO. CK-D.14

(3) CATCH BASIN TYPE 2 PER COK PLAN NO CK-D.09.

REPLACE STORM DRAIN MANHOLE LID PER COK PLAN NO CK-D18A.

SEWER CONSTRUCTION NOTES:

REHABILITATE EXISTING MANHOLE AND INSTALL CURB COVER. SEE DETAIL 1 ON STORM AND SEWER DETAILS AND MANHOLE RESTORATION NOTES BELOW.

SEWER MANHOLE RESTORATION NOTES:

EXISTING CONDITION: THE MANHOLE CONSISTS OF TWO FRAMES, STACKED, AND A COVER.

PROPOSED: REMOVE AND DISPOSE OF EXISTING FRAMES AND COVER. PROVIDE AND INSTALL NEW FRAME, COVER ADJUSTING RINGS AND CURB COVER IN ACCORDANCE WITH NUD STANDARD SEWER DETAILS 1 AND 5, AND CURB COVER DETAILS, SHEET 10.

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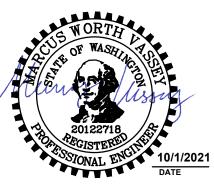
CITY OF KIRKLAND

DEPARTMENT OF PUBLIC WORKS

123 FIFTH AVENUE KIRKLAND, WA 98033

(425) 587–3800 www.kirklandwa.gov

NO. DATE BY APPR. REVISION



APPROVED BY:

DATE: 10/5/2021

 M. VASSEY
 7/2021

 DESIGNED BY:
 DATE

 M. VASSEY
 7/2021

 DRAWN BY:
 DATE

 D. SCHNEIDER
 7/2021

 CHECKED BY:
 DATE

STORM AND SEWER PLAN AND PROFILE

ENGINEERING . PLANNING . ENVIRONMENTAL SCIENCES

Parametrix

NE 124TH ST / 116TH AVE NE INTERSECTION IMPROVEMENTS
CITY OF KIRKLAND, WA


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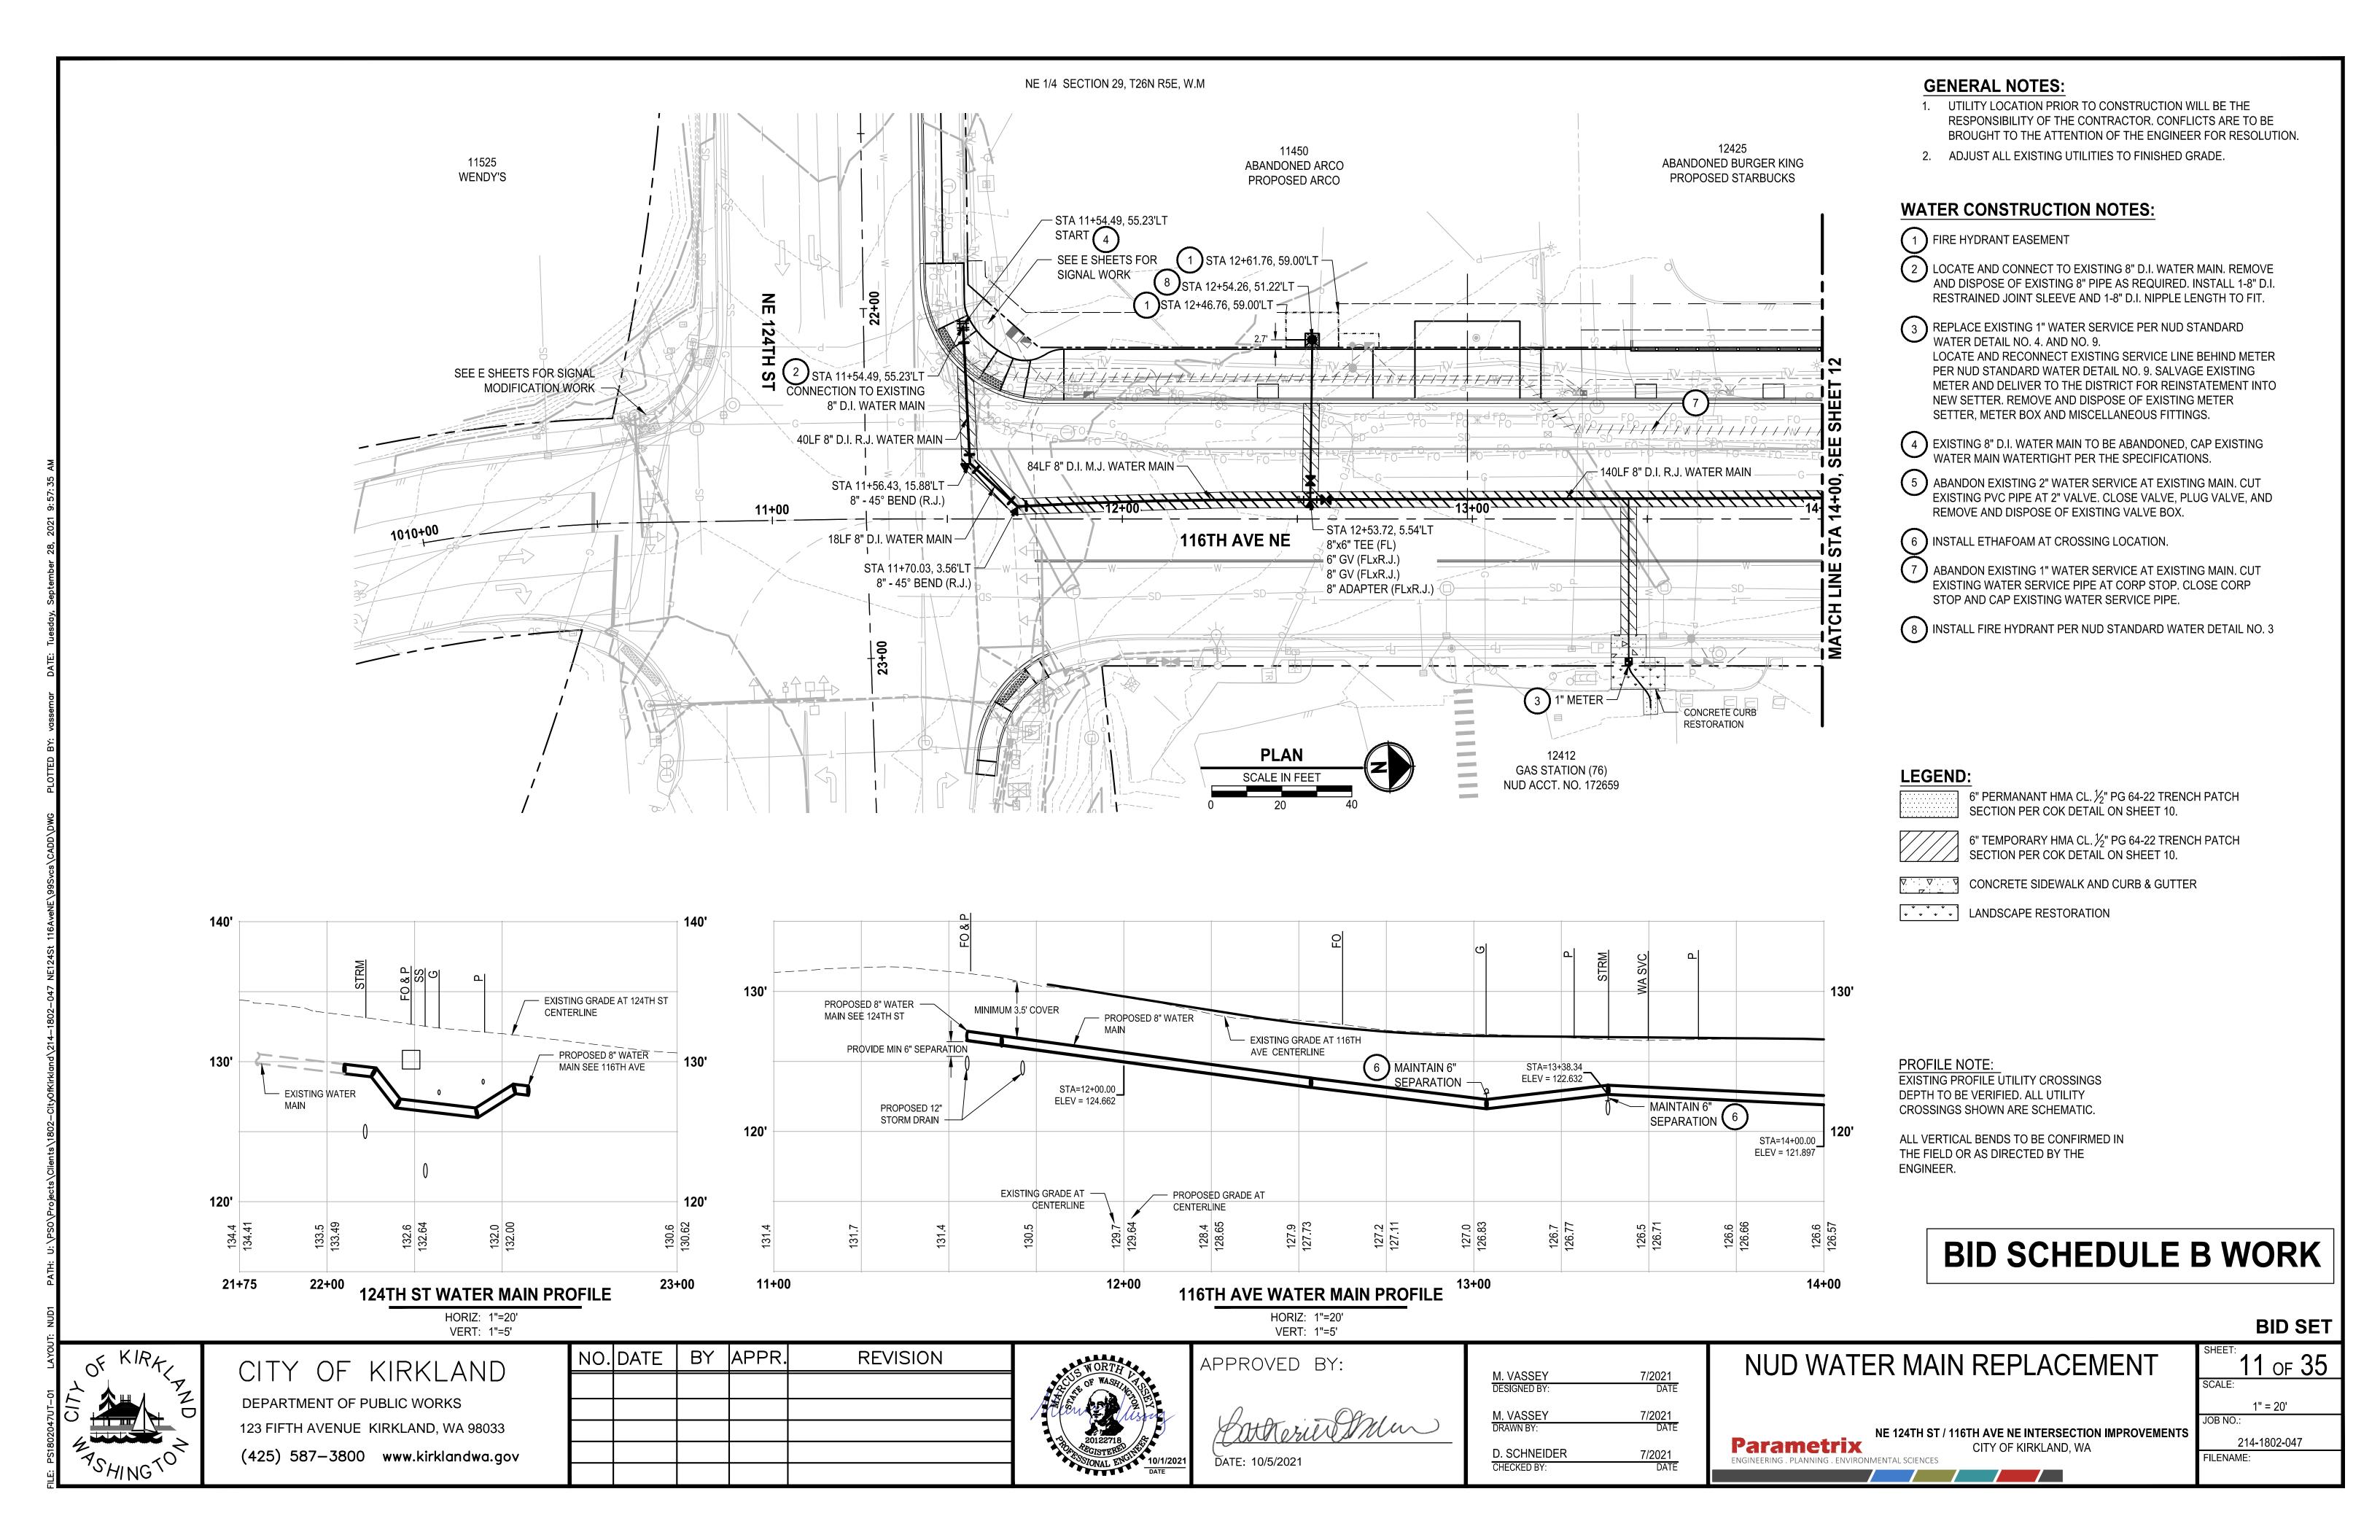
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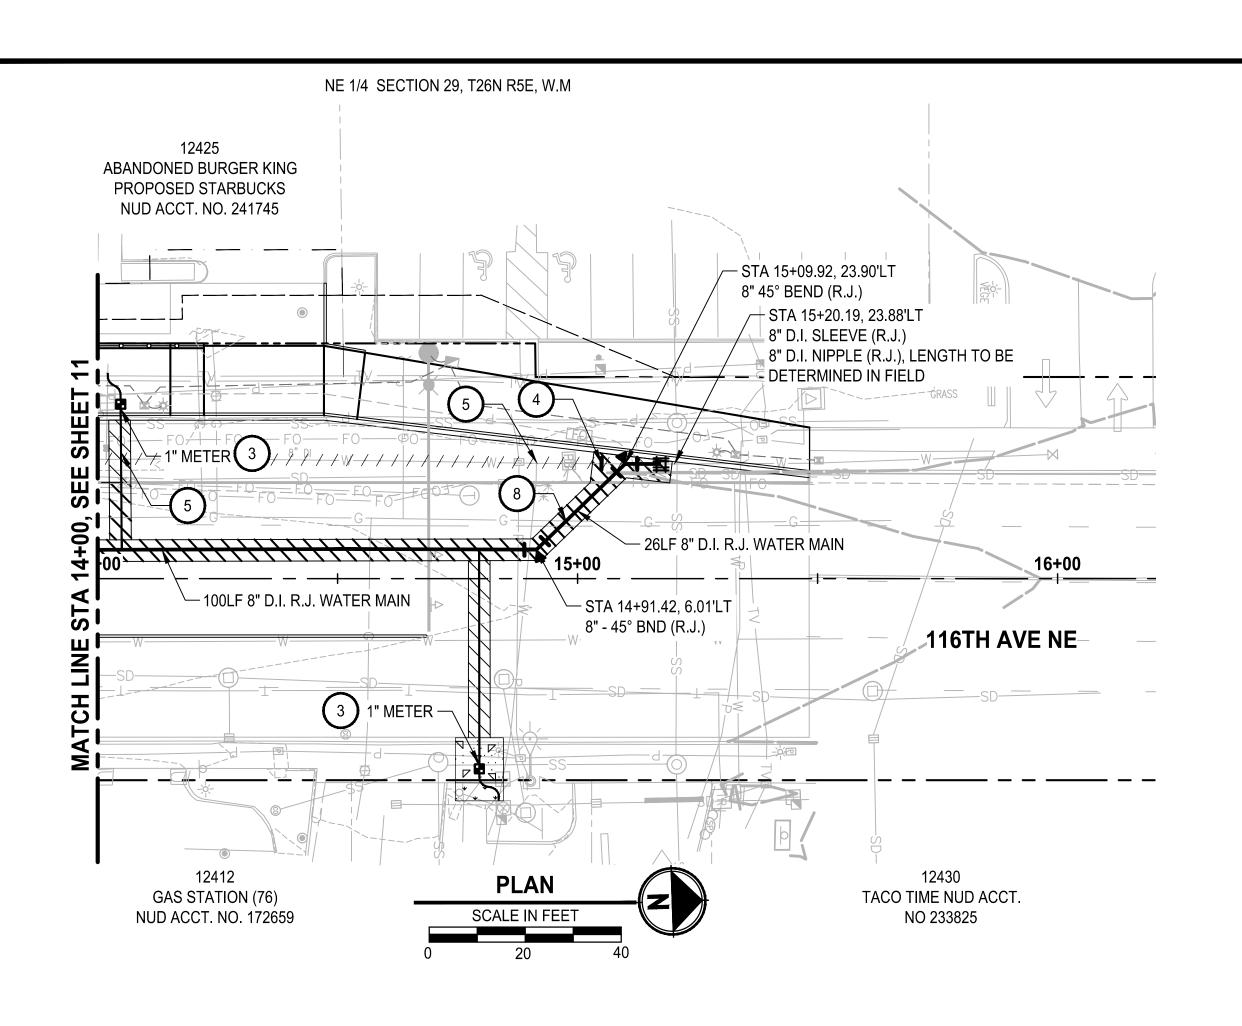
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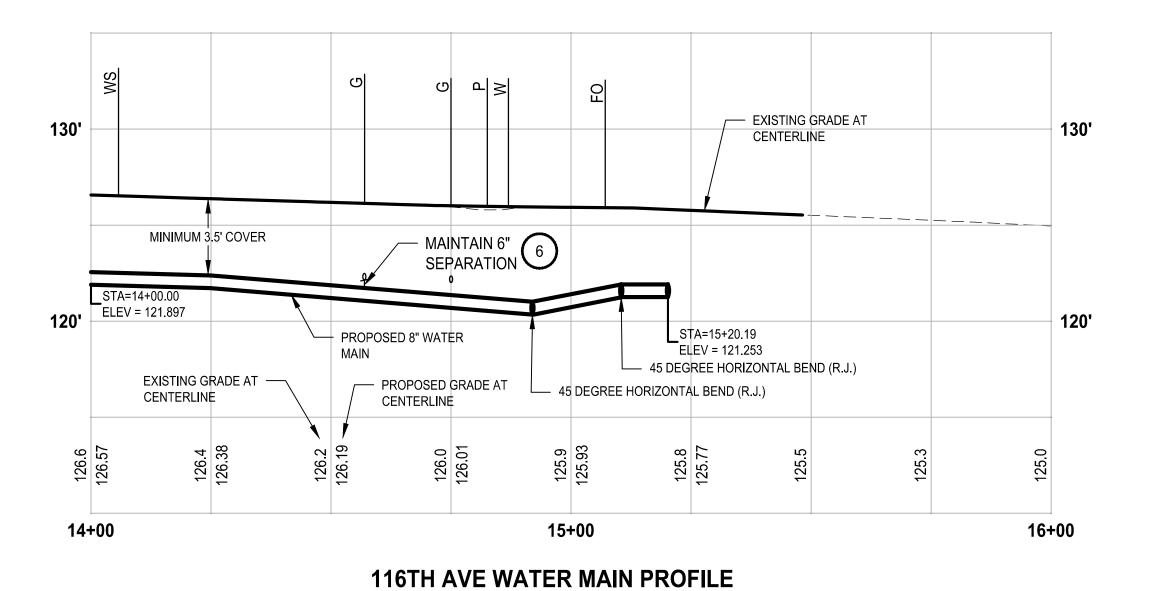
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HORIZ: 1"=20' VERT: 1"=5'

PROFILE NOTE: **EXISTING PROFILE UTILITY CROSSINGS** DEPTH TO BE VERIFIED. ALL UTILITY CROSSINGS SHOWN ARE SCHEMATIC.

ALL VERTICAL BENDS TO BE CONFIRMED IN THE FIELD OR AS DIRECTED BY THE ENGINEER.

GENERAL NOTES:

- UTILITY LOCATION PRIOR TO CONSTRUCTION WILL BE THE RESPONSIBILITY OF THE CONTRACTOR. CONFLICTS ARE TO BE BROUGHT TO THE ATTENTION OF THE ENGINEER FOR RESOLUTION.
- 2. ADJUST ALL EXISTING UTILITIES TO FINISHED GRADE.

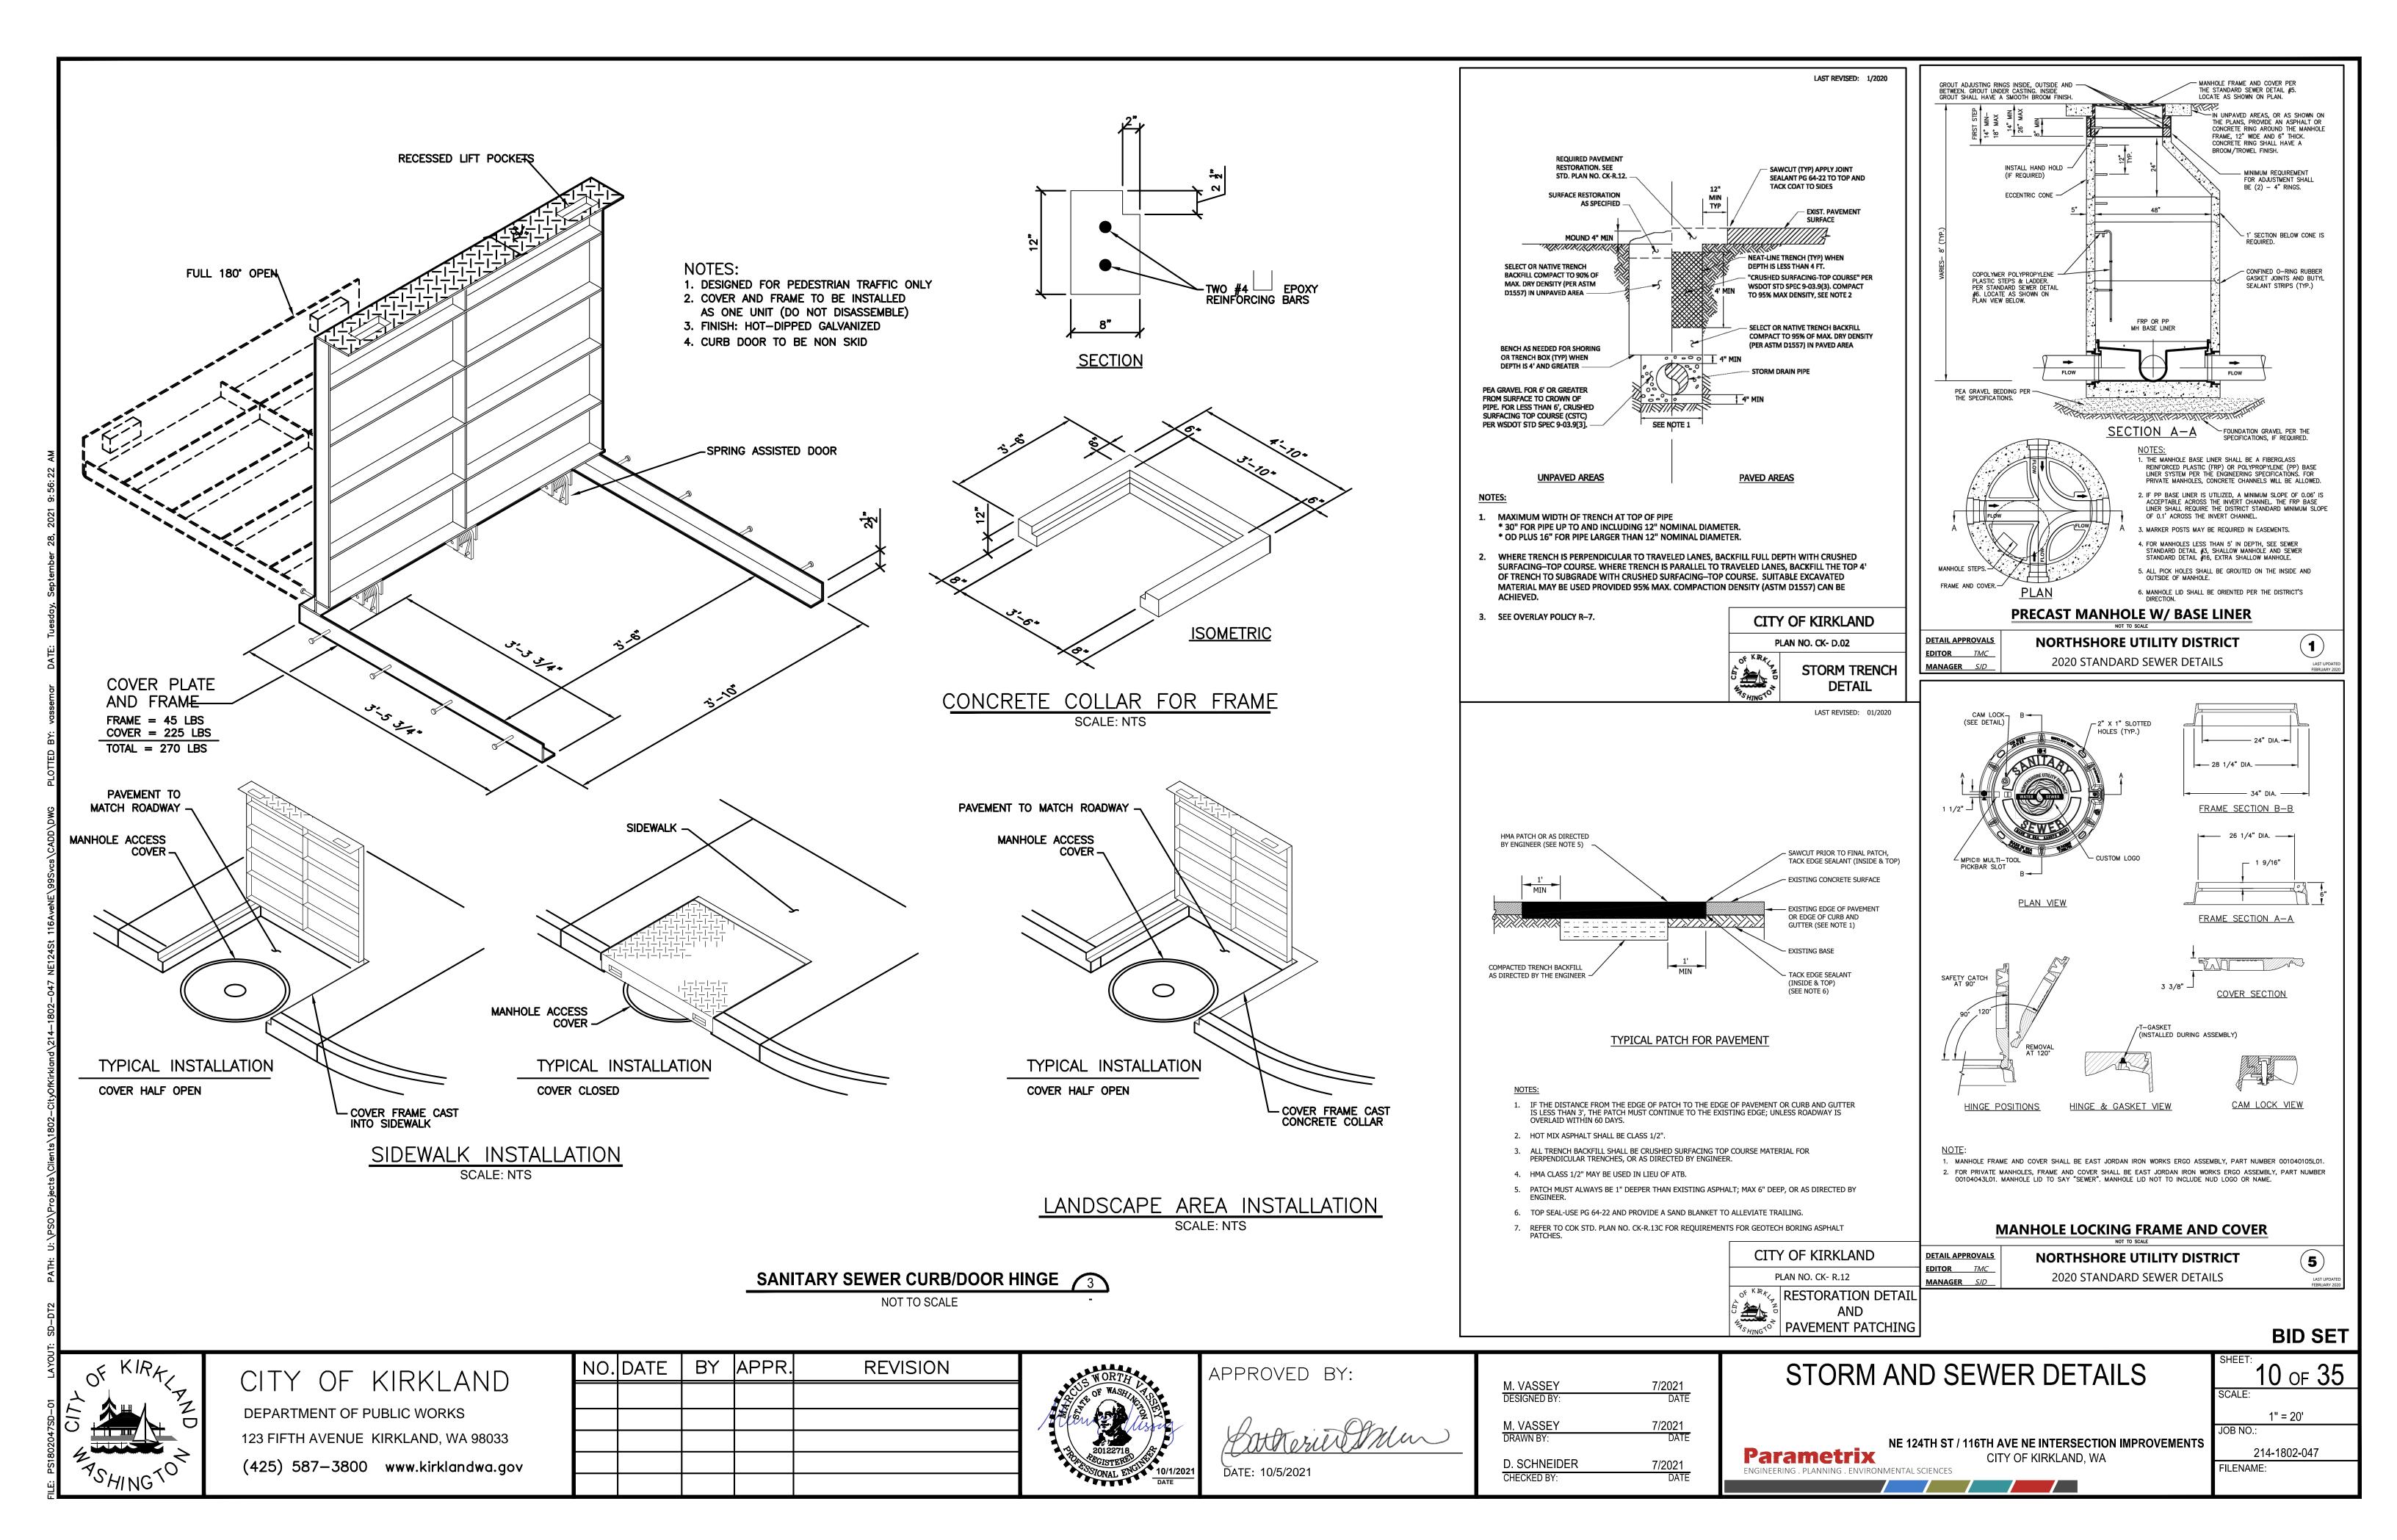WATER CONSTRUCTION NOTES:

1 FIRE HYDRANT EASEMENT

2 LOCATE AND CONNECT TO EXISTING 8" D.I. WATER MAIN. REMOVE AND DISPOSE OF EXISTING 8" PIPE AS REQUIRED. INSTALL 1-8" D.I. RESTRAINED JOINT SLEEVE AND 1-8" D.I. NIPPLE LENGTH TO FIT.

REPLACE EXISTING 1" WATER SERVICE PER NUD STANDARD WATER DETAIL NO. 4. AND NO. 9. LOCATE AND RECONNECT EXISTING SERVICE LINE BEHIND METER PER NUD STANDARD WATER DETAIL NO. 9. SALVAGE EXISTING METER AND DELIVER TO THE DISTRICT FOR REINSTATEMENT INTO NEW SETTER. REMOVE AND DISPOSE OF EXISTING METER SETTER, METER BOX AND MISCELLANEOUS FITTINGS.

4 EXISTING 8" D.I. WATER MAIN TO BE ABANDONED, CAP EXISTING WATER MAIN WATERTIGHT PER THE SPECIFICATIONS.

ABANDON EXISTING 2" WATER SERVICE AT EXISTING MAIN. CUT EXISTING PVC PIPE AT 2" VALVE. CLOSE VALVE, PLUG VALVE, AND REMOVE AND DISPOSE OF EXISTING VALVE BOX.

(6) INSTALL ETHAFOAM AT CROSSING LOCATION.

(7) ABANDON EXISTING 1" WATER SERVICE AT EXISTING MAIN. CUT EXISTING WATER SERVICE PIPE AT CORP STOP. CLOSE CORP STOP AND CAP EXISTING WATER SERVICE PIPE.

(8) INSTALL FIRE HYDRANT PER NUD STANDARD WATER DETAIL NO. 3

LEGEND:

6" PERMANANT HMA CL. $\frac{1}{2}$ " PG 64-22 TRENCH PATCH SECTION PER COK DETAIL ON SHEET 10.

6" TEMPORARY HMA CL. $\frac{1}{2}$ " PG 64-22 TRENCH PATCH SECTION PER COK DETAIL ON SHEET 10.

CONCRETE SIDEWALK AND CURB & GUTTER

LANDSCAPE RESTORATION


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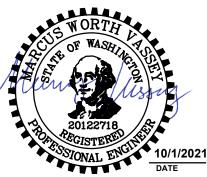
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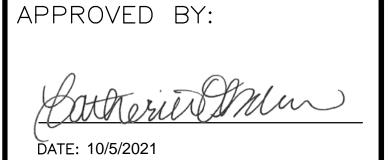


CITY OF KIRKLAND

DEPARTMENT OF PUBLIC WORKS 123 FIFTH AVENUE KIRKLAND, WA 98033 (425) 587-3800 www.kirklandwa.gov





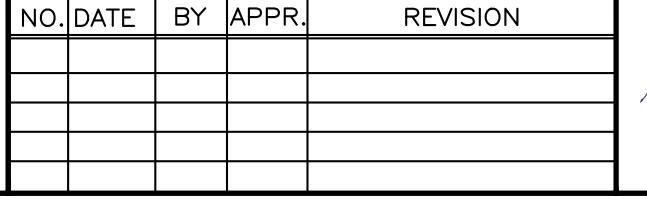

M. VASSEY DESIGNED BY:	7/2021 DATE
M. VASSEY DRAWN BY:	7/2021 DATE
D. SCHNEIDER CHECKED BY:	7/2021 DATE

NUD WATER MAIN REPLACEMENT


Parametrix


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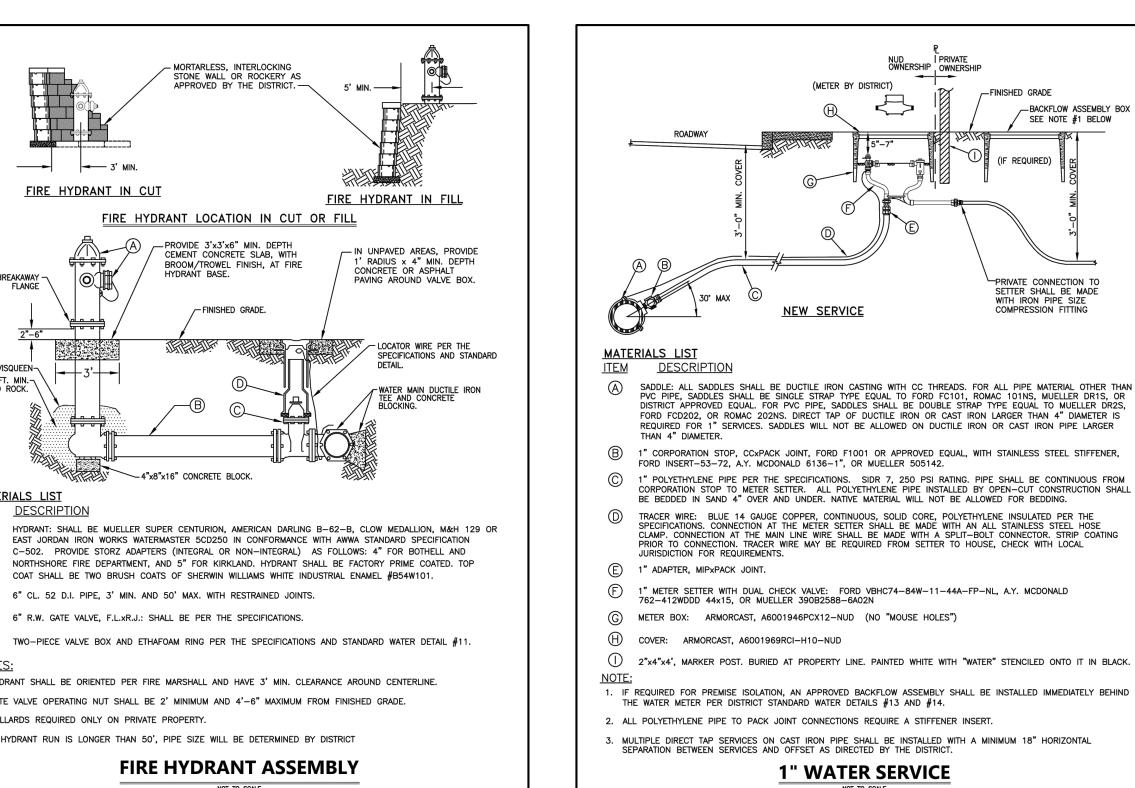
12 of 35


NE 124TH ST / 116TH AVE NE INTERSECTION IMPROVEMENTS CITY OF KIRKLAND, WA

1" = 20' 214-1802-047 FILENAME:



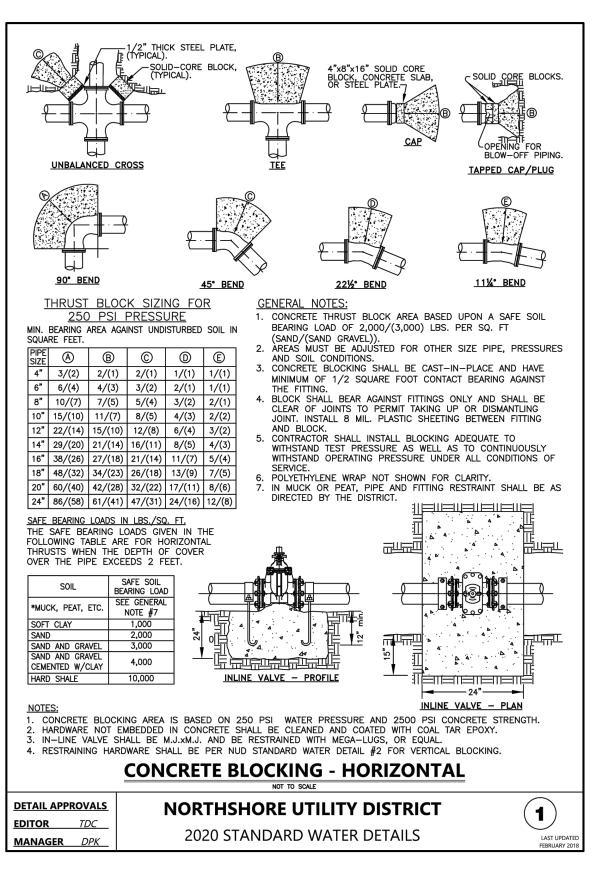

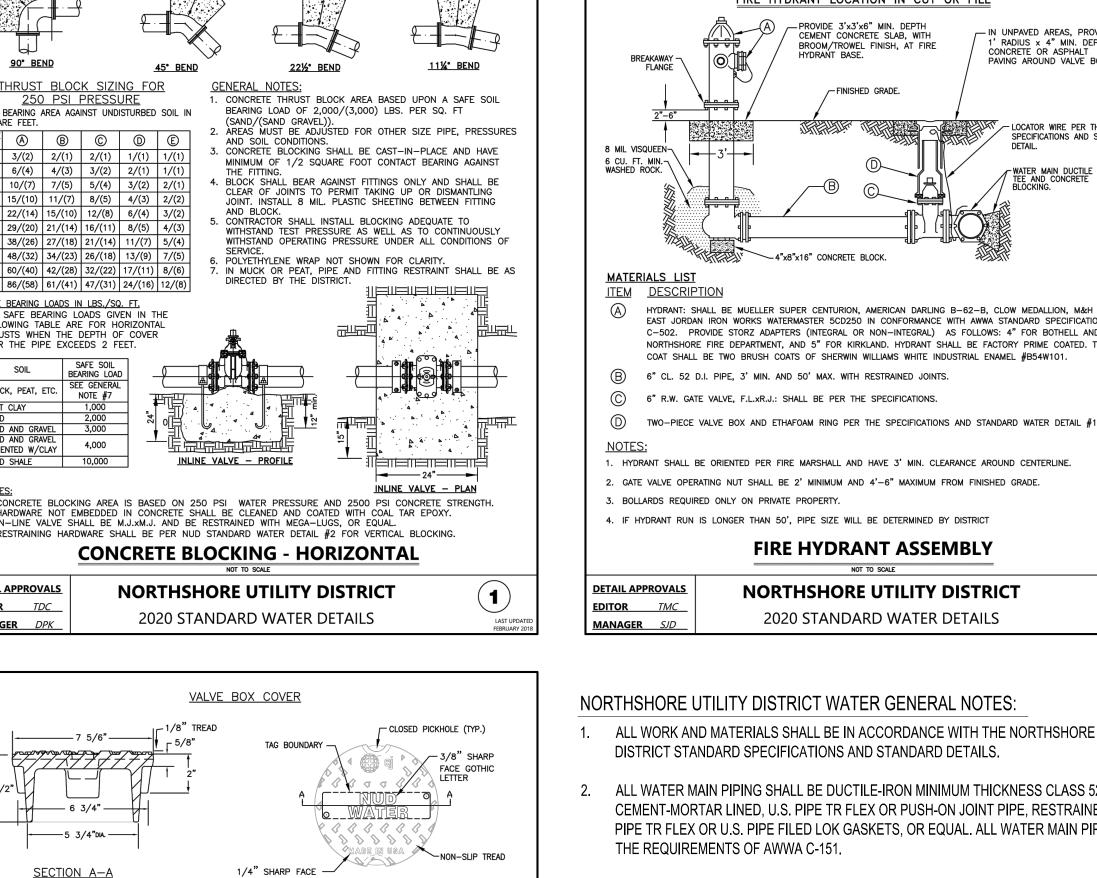

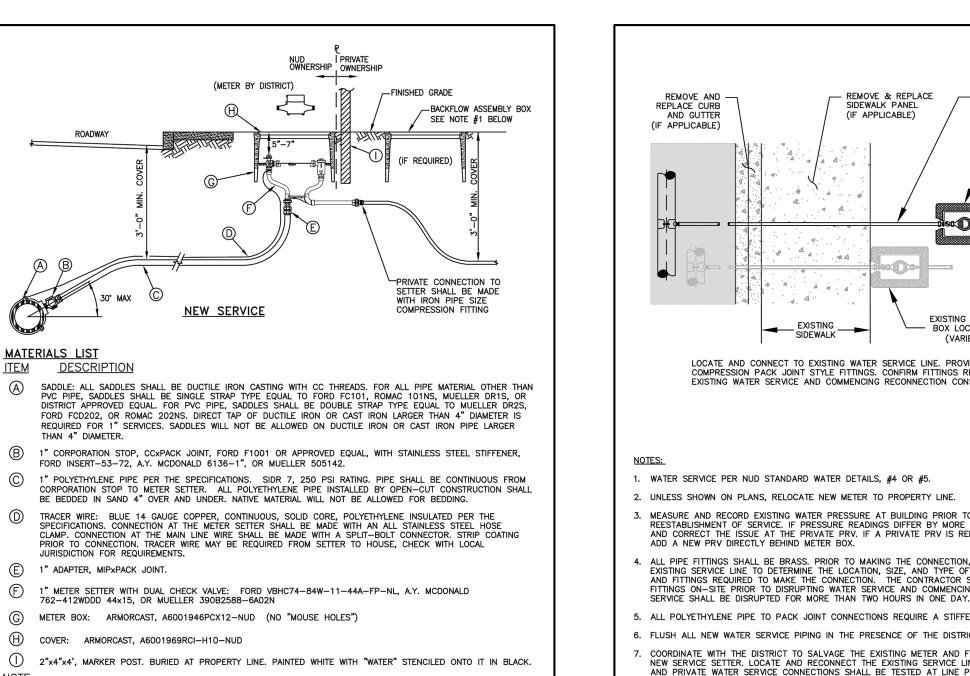

1" WATER SERVICE


NORTHSHORE UTILITY DISTRICT

2020 STANDARD WATER DETAILS

DETAIL APPROVALS

EDITOR TMC

MANAGER SJD

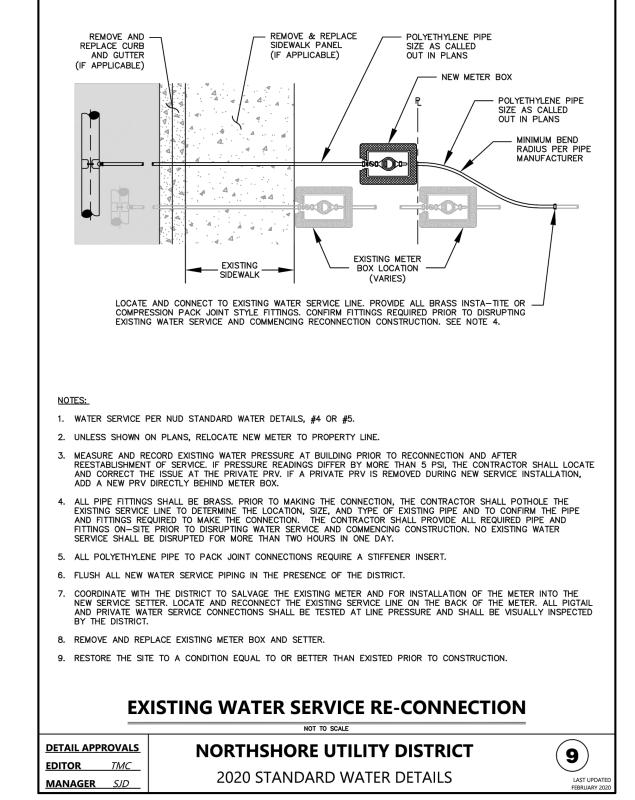

BID SET

13 of 35



DETAIL APPROVALS

EDITOR TMC

MANAGER SJD

5. INSTALL ETHAFOAM RING BETWEEN BASE OF VALVE BOX AND GATE VALVES OR ON CONCRETE BRICKS FOR BALL


CITY OF KIRKLAND


PIPE BETWEEN VALVE BOX TOP AND VALVE BOX BOTTOM. LENGTH TO FIT.


11


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NUD WATER DETAILS


Parametrix

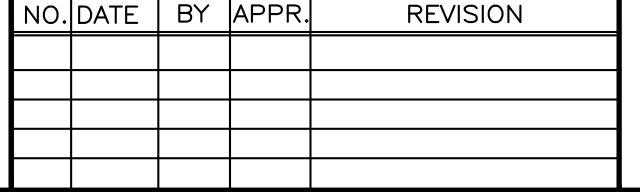ENGINEERING . PLANNING . ENVIRONMENTAL SCIENCES

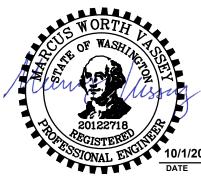NE 124TH ST / 116TH AVE NE INTERSECTION IMPROVEMENTS

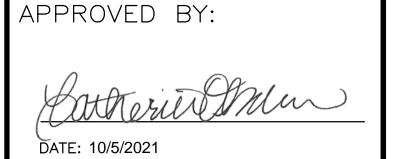CITY OF KIRKLAND, WA

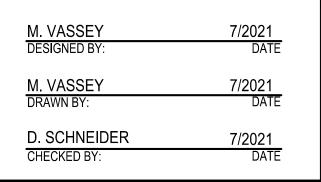1" = 20' 214-1802-047 FILENAME:

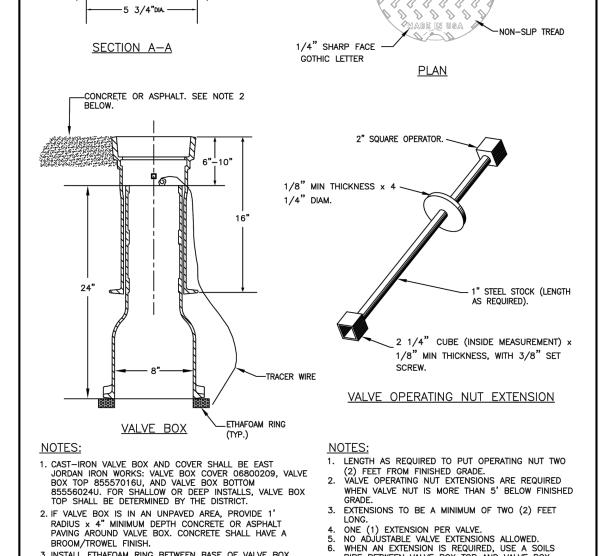


VALVE BOX & OPERATING NUT EXTENSION


NORTHSHORE UTILITY DISTRICT


2020 STANDARD WATER DETAILS

- ALL WORK AND MATERIALS SHALL BE IN ACCORDANCE WITH THE NORTHSHORE UTILITY
- ALL WATER MAIN PIPING SHALL BE DUCTILE-IRON MINIMUM THICKNESS CLASS 52, CEMENT-MORTAR LINED, U.S. PIPE TR FLEX OR PUSH-ON JOINT PIPE, RESTRAINED WITH U.S. PIPE TR FLEX OR U.S. PIPE FILED LOK GASKETS, OR EQUAL. ALL WATER MAIN PIPING TO MEET
- ALL WATER MAIN FITTINGS SHALL BE CEMENT MORTAR LINED AND MEET THE REQUIREMENTS OF AWWA C-152. ALL MECHANICAL JOINT FITTINGS SHALL BE RESTRAINED WITH EBAA IRON, INC. MEGA-LUG MECHANICAL JOINT RESTRAINTS, OR EQUAL
- POLYETHYLENE ENCASEMENT TO MEET THE AWWA STANDARD C-105. ANY TEARS OR OPENINGS MADE FOR SERVICES OR TAPS SHALL BE REPAIRED WITH AN ADHESIVE TAPE.
- ALL WATER MAIN PIPES, CONTINUOUS, SOLID CORE, NEOPRENE COATED LOCATING WIRE. ANY CONNECTIONS OR SPLICES SHALL BE MADE WITH SPLIT-BOLT WIRE CONNECTORS.


BID SCHEDULE B WORK

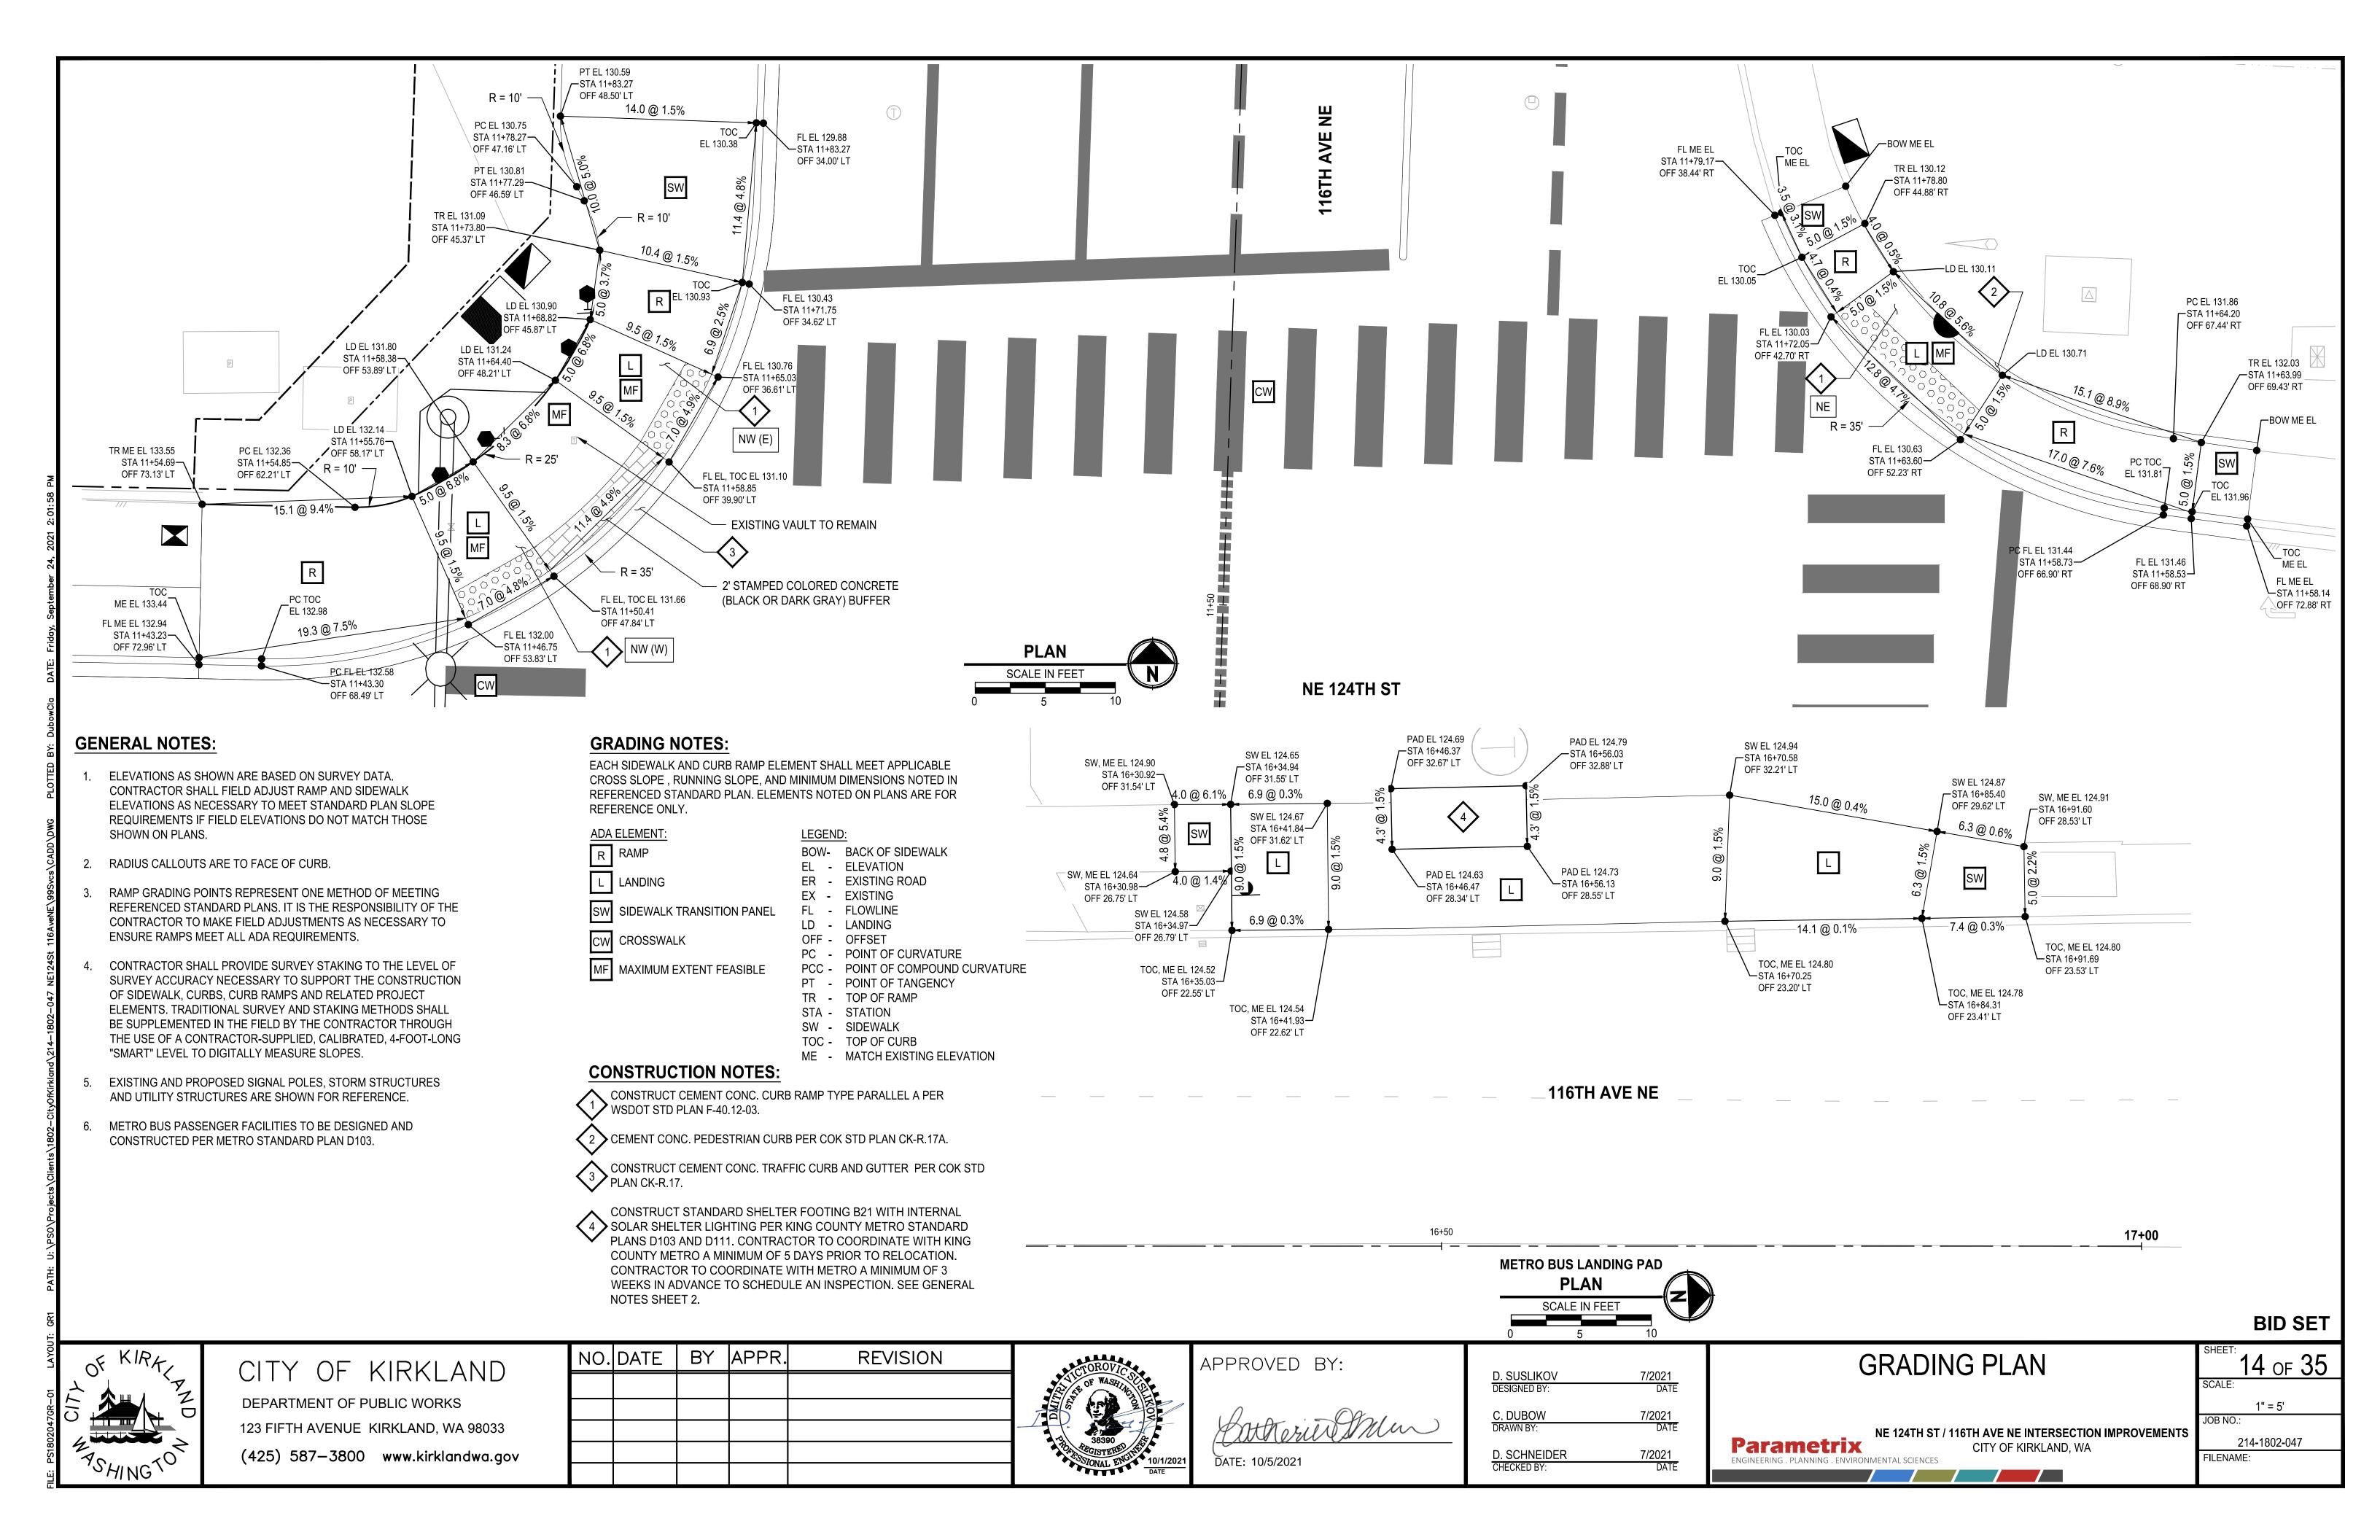

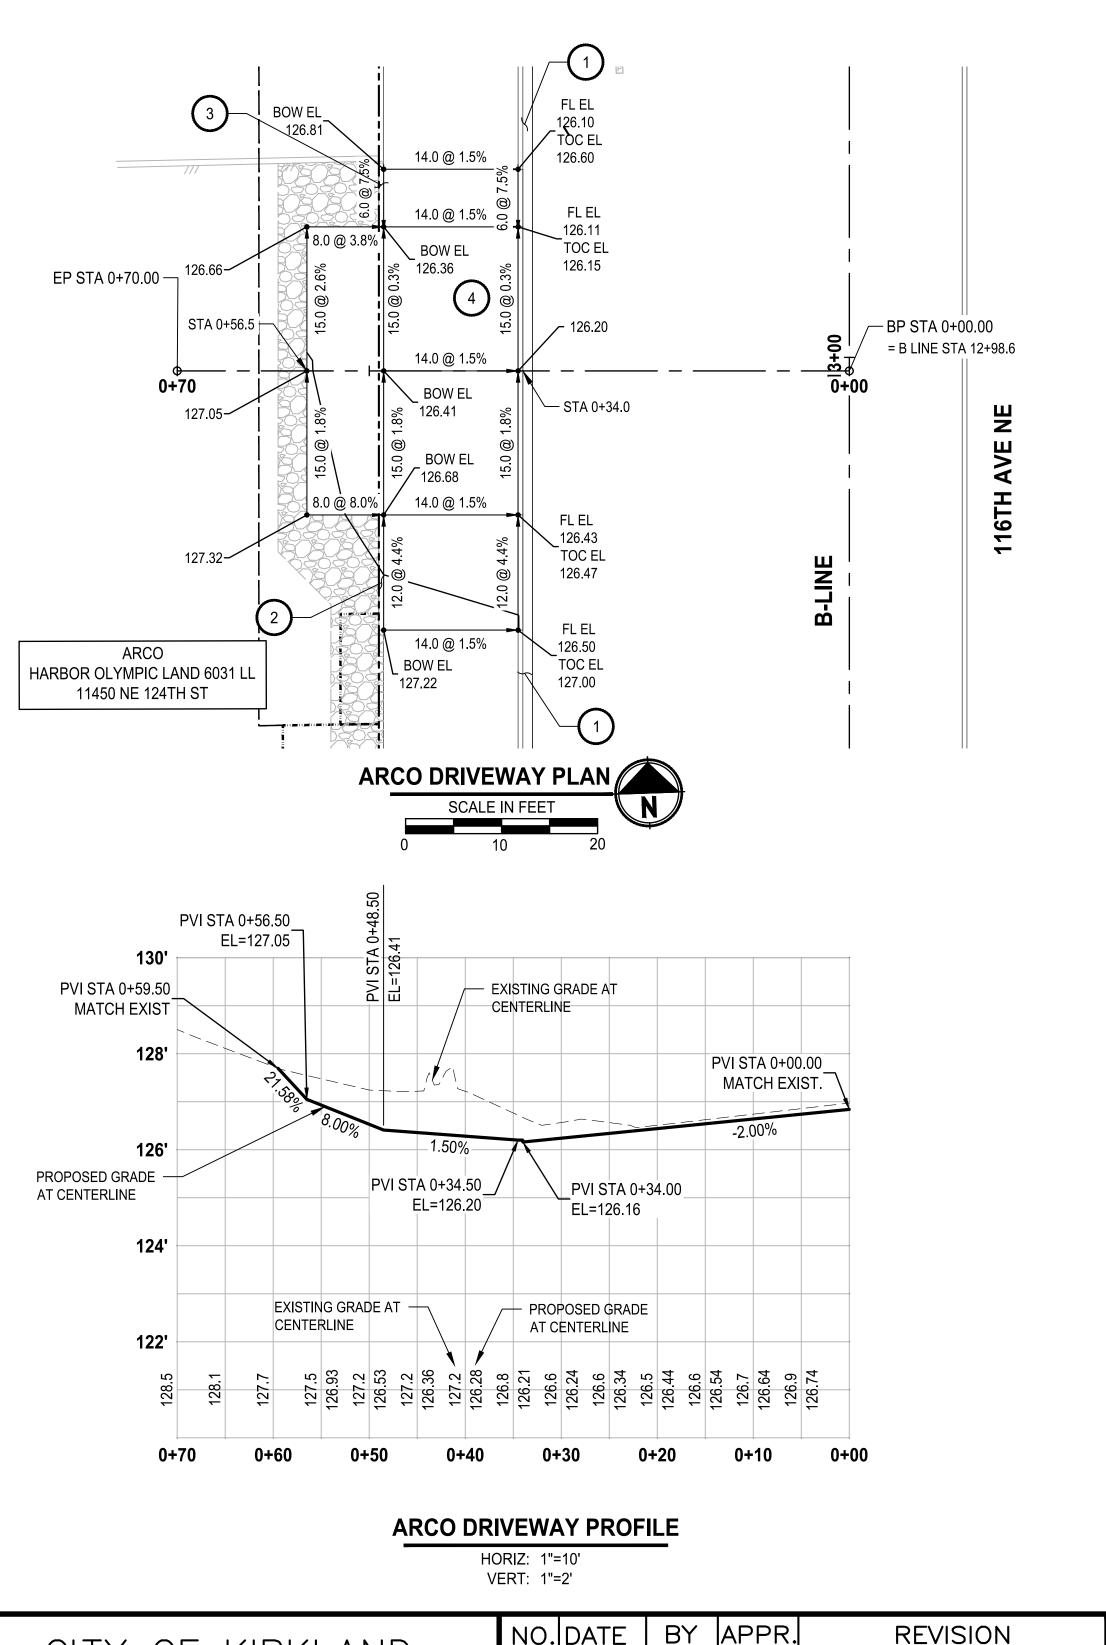

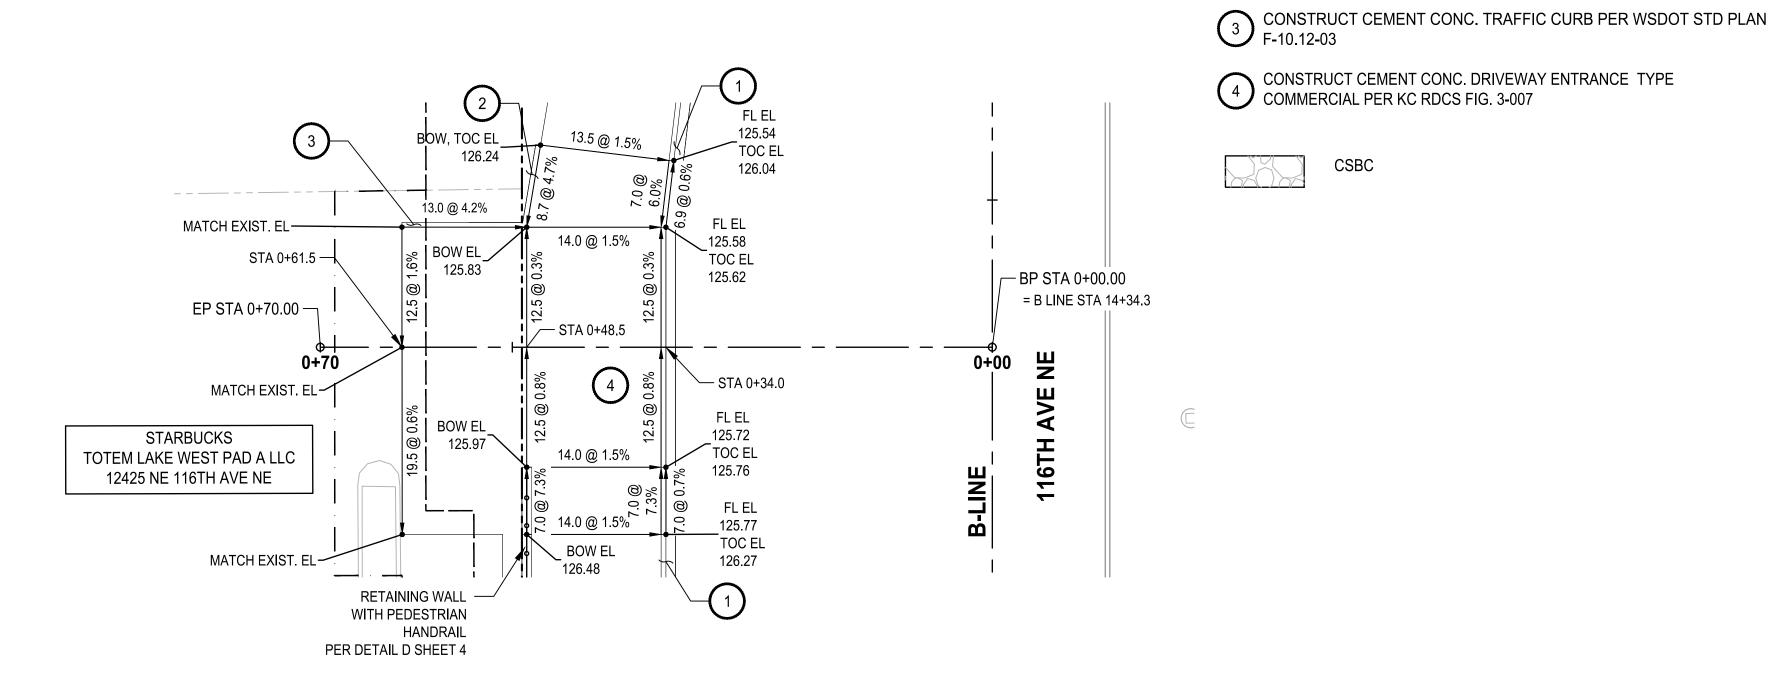

STARBUCKS DRIVEWAY PLAN

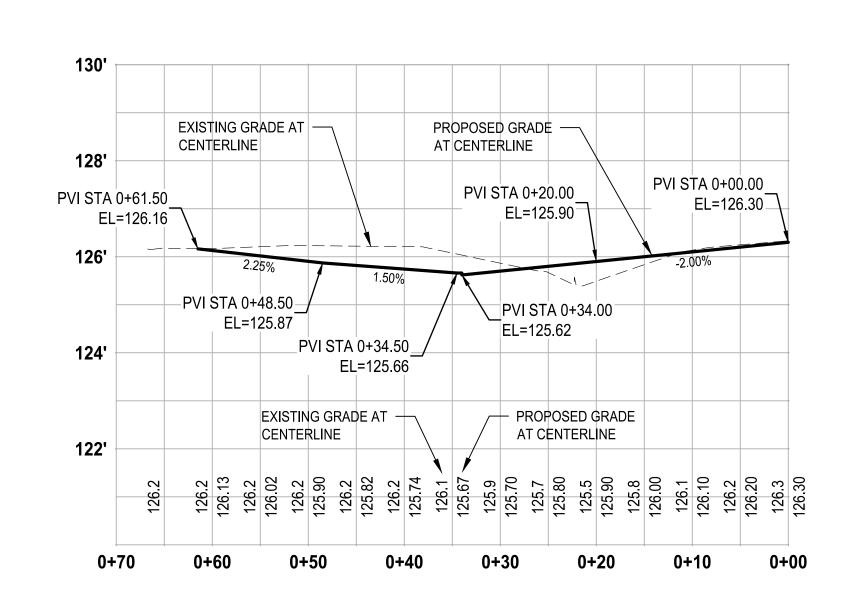

STARBUCKS DRIVEWAY PROFILE

HORIZ: 1"=10' VERT: 1"=2'

BID SET

CITY OF KIRKLAND DEPARTMENT OF PUBLIC WORKS 123 FIFTH AVENUE KIRKLAND, WA 98033

(425) 587-3800 www.kirklandwa.gov

., ,) .		, ,, , , , ,	1121101011





APPROVED BY:

D. SUSLIKOV	7/2021
DESIGNED BY:	DATE
C. DUBOW	7/2021
DRAWN BY:	DATE
D. SCHNEIDER	7/2021
CHECKED BY:	DATE

DRIVEWAY PLAN AND PROFILE

NE 124TH ST / 116TH AVE NE INTERSECTION IMPROVEMENTS **Parametrix** CITY OF KIRKLAND, WA ENGINEERING . PLANNING . ENVIRONMENTAL SCIENCES

CONSTRUCTION NOTES:


CSBC

CONSTRUCT CEMENT CONC. TRAFFIC CURB AND GUTTER, TYPE "A", PER COK STD PLAN CK-R.17

CONSTRUCT CEMENT CONC. PEDESTRIAN CURB PER COK STD PLAN CK-R.17A

15 of 35 1" = 10'

214-1802-047 FILENAME:

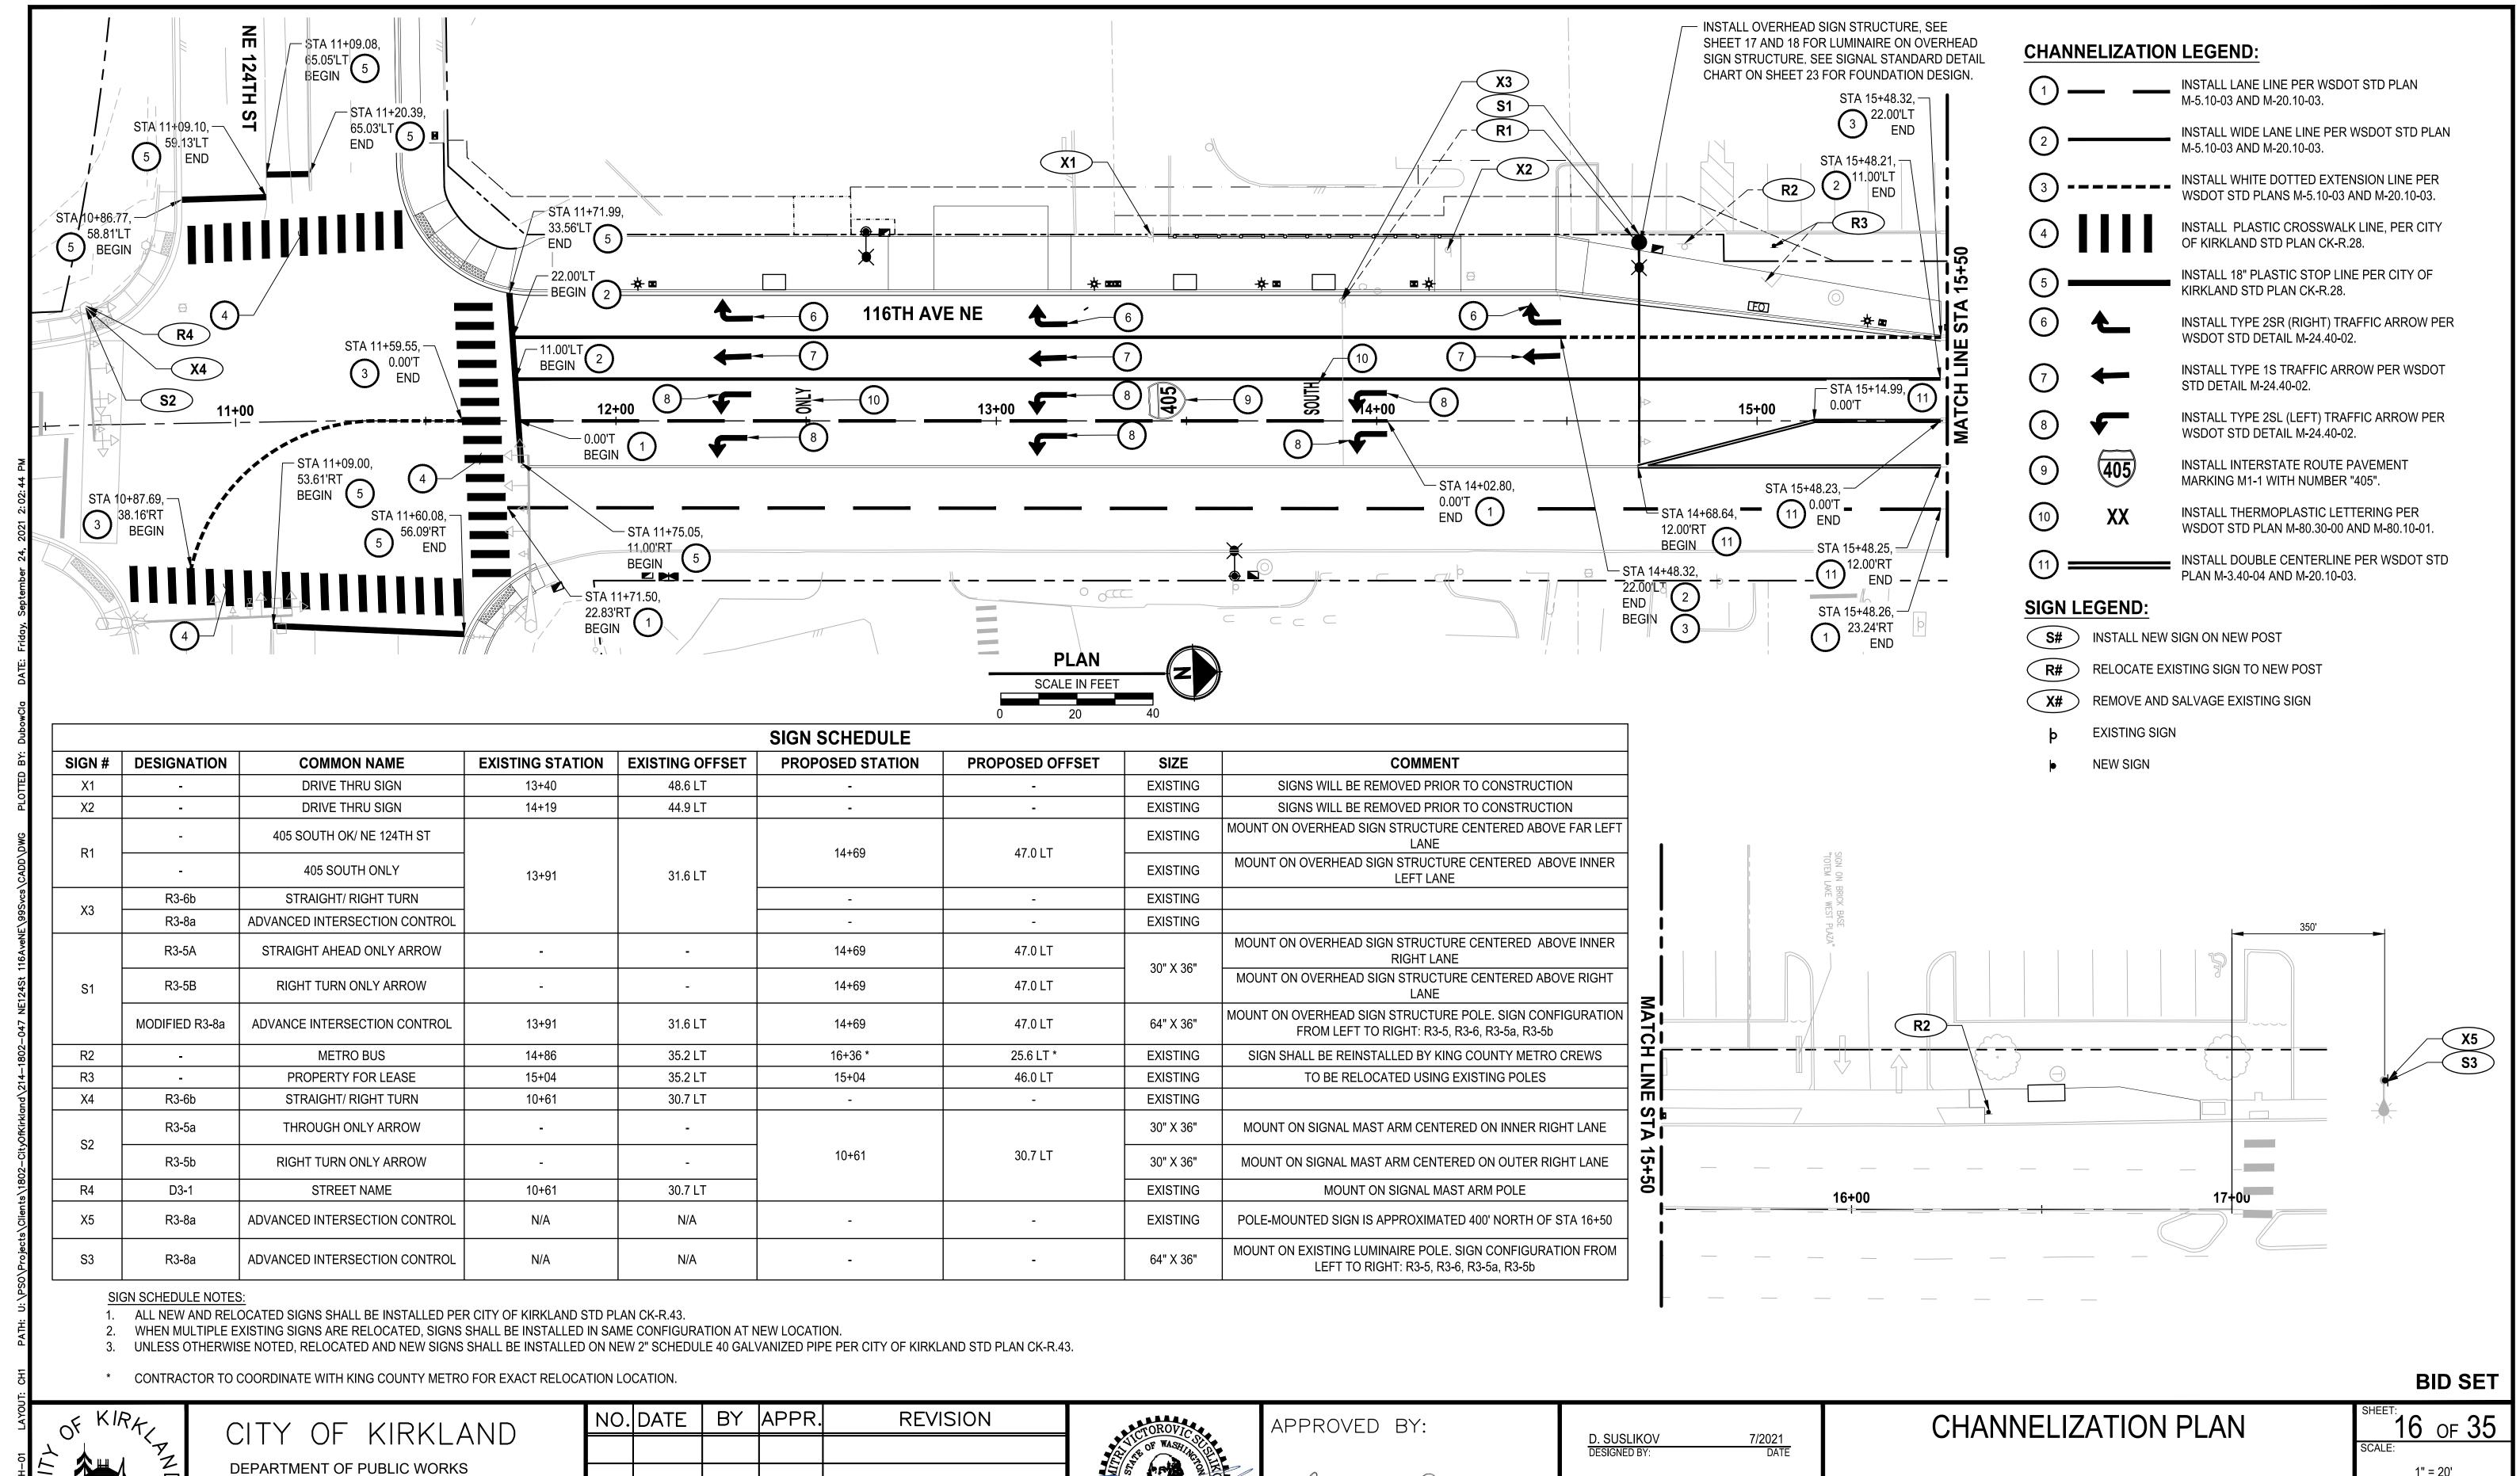

DATE: 10/5/2021

123 FIFTH AVENUE KIRKLAND, WA 98033

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TI" = 20'

JOB NO.:

NE 124TH ST / 116TH AVE NE INTERSECTION IMPROVEMENTS
CITY OF KIRKLAND, WA

ENGINEERING . PLANNING . ENVIRONMENTAL SCIENCES

1" = 20'

JOB NO.:
214-1802-047

FILENAME:


7/2021 DATE

7/2021 DATE

C. DUBOW DRAWN BY:

CHECKED BY:

D. SCHNEIDER

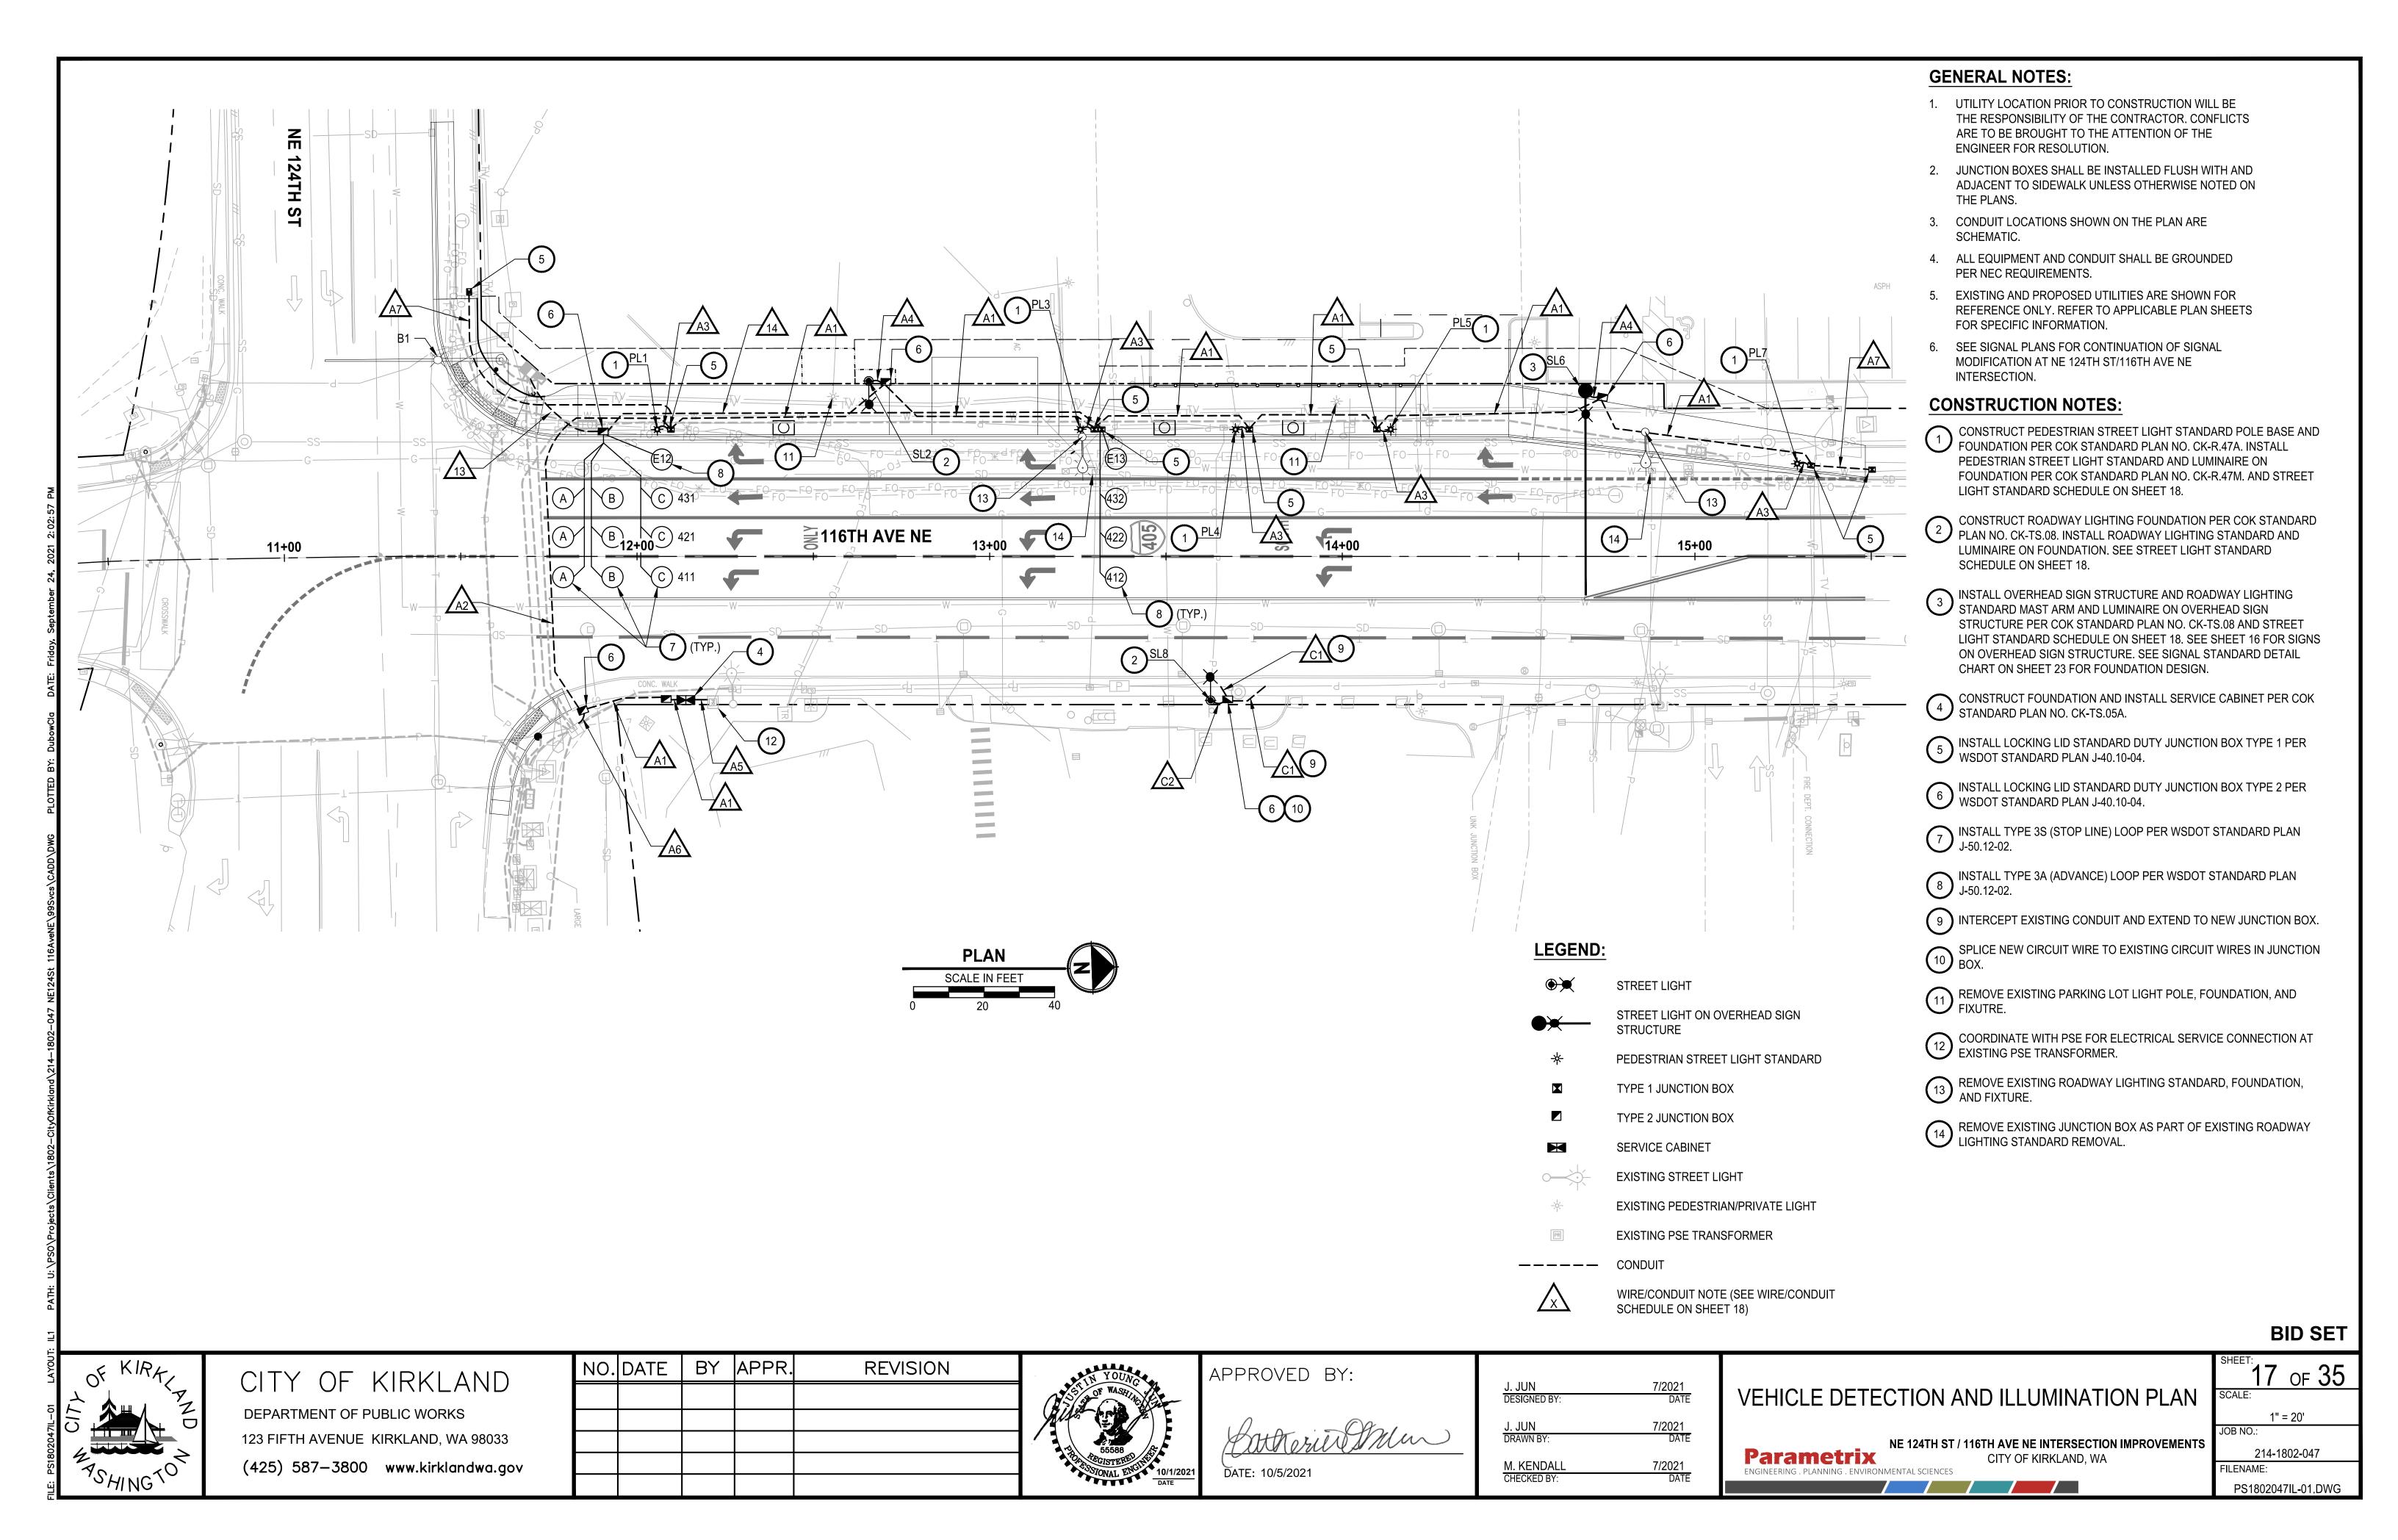

★ MOUNT ON TYPE 3 SIGNAL POLE. SEE SIGNAL STANDARD DETAIL CHART - NE 124TH ST & 116TH AVE NE INTERSECTION ON SHEET POLE SCHEDULE.


STREET LIGHT STANDARD SCHEDULE NOTES:

- 1. OFFSETS IN TABLE ARE TO THE CENTER OF THE POLE. OFFSETS ARE APPROXIMATE AND SHALL BE MODIFIED IN THE FIELD TO 1.5 FT FROM BACK OF CURB AND GUTTER TO CENTER OF THE POLE OR FACE OF FOUNDATION AT BACK OF SIDEWALK.
- 2. TOP OF FOUNDATION SHALL BE FLUSH WITH ADJACENT SIDEWALK.
- 3. MOUNTING HEIGHT IS MEASURED FROM THE SIDEWALK SURFACE TO THE BOTTOM OF THE FIXTURE.
- 4. OPTIC OF PEDESTRIAN FIXTURE SHALL AIM TOWARDS SIDEWALK (NOT THE ROADWAY).
- 5. FIXTURE ON PL1, PL3, PL4, PL5, AND PL7 SHALL BE LUMEC CANDELA SERIES CAND2, 65W, 5600 LUMENS, 4K CCT, TYPE III DISTRIBUTION (MODEL: CAND2-65W42LED4K-G2-PC-C-RLE3-240).
- 6. FIXTURE ON SL2, SL6, B1, AND SL8 SHALL BE AUTOBAHN SERIES ATBM, 94W, 12,800 LUMENS, 4K CCT, TYPE III DISTRIBUTION (MODEL: ATBM-P20-MVOLT-R3).

			WIR	RE/CONDUIT S	CHEDULE				
RUN	CONDUIT TYPE	VEH. DET. LOOP		ILLUMINATION					
			SERVICE A CIRCUIT 5	RECEPTACLE CIRCUIT 13	MATCH EXISTING CIRCUIT	POWER			
A1	2"		2-#8	2-#8					
A 2	2"		2-#8	2-#8					
A2	3"						SPARE		
A3	1"		2-#8	2-#8					
A4	2"		2-#8						
A5	2"					3-3/0			
A6	3"						SPARE		
A7	2"						SPARE		
C1	MATCH EXISTING				2-#8				
C2	2"				2-#8				
13	2"	8-2CS							
14	2"	4-2CS							

WIRE/CONDUIT SCHEDULE NOTES:

- 1. ALL PROPOSED CONDUIT SHALL BE PVC SCHEDULE 80 UNLESS OTHERWISE SPECIFIED.
- 2. ALL CONDUITS CONTAINING CONDUCTORS SHALL INCLUDE A GROUND WIRE, NOT SHOWN IN THE WIRE/CONDUIT SCHEDULE. GROUND WIRE SHALL MATCH THE LARGEST CONDUCTOR (MIN. #8 UNLESS OTHERWISE NOTED).

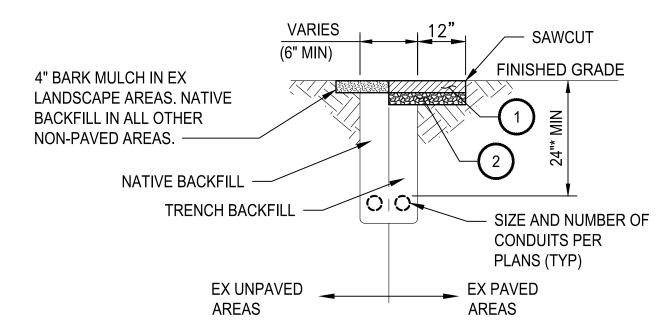

TRENCH PAVEMENT RESTORATION NOTES:

- PAVEMENT RESTORATION. HMA CL ½" PG 64-22 DEPTH TO MATCH PROPOSED FULL DEPTH. SEE RS SHEETS.
- (2) CSBC DEPTH TO MATCH PROPOSED FULL DEPTH. SEE RS SHEETS.
 - * ADJUST DEPTH OF COVER AS REQUIRED TO PROVIDE 6" MIN CLEARANCE FROM EXISTING UTILITIES AND PROPOSED STORM DRAINS.

ILLUMINATION TRENCH DETAIL NO SCALE 1

GENERAL NOTES:

1. CIRCUIT 1, 5, 10, AND 13 SHALL BE PER COK STANDARD PLAN NO. CK-TS.05B PANELBOARD SCHEDULE "S". OTHER CIRCUIT SHOWN ON PANELBOARD SCHEDULE "S" SHALL BE SPARE.

BID SET




CITY OF KIRKLAND


DEPARTMENT OF PUBLIC WORKS

123 FIFTH AVENUE KIRKLAND, WA 98033


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NO. DATE BY APPR. REVISION



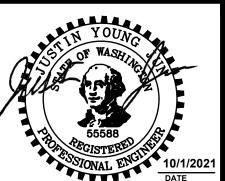

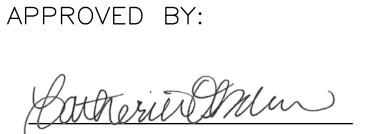DATE: 10/5/2021



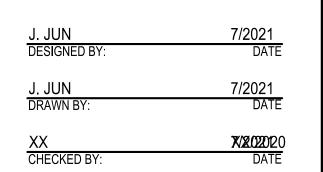

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NE 124TH ST / 116TH AVE NE INTERSECTION IMPROVEMENTS


CITY OF KIRKLAND, WA


18 OF 35

SCALE:
N/A

JOB NO.:
214-1802-047

FILENAME:
PS1802047IL-01.DWG

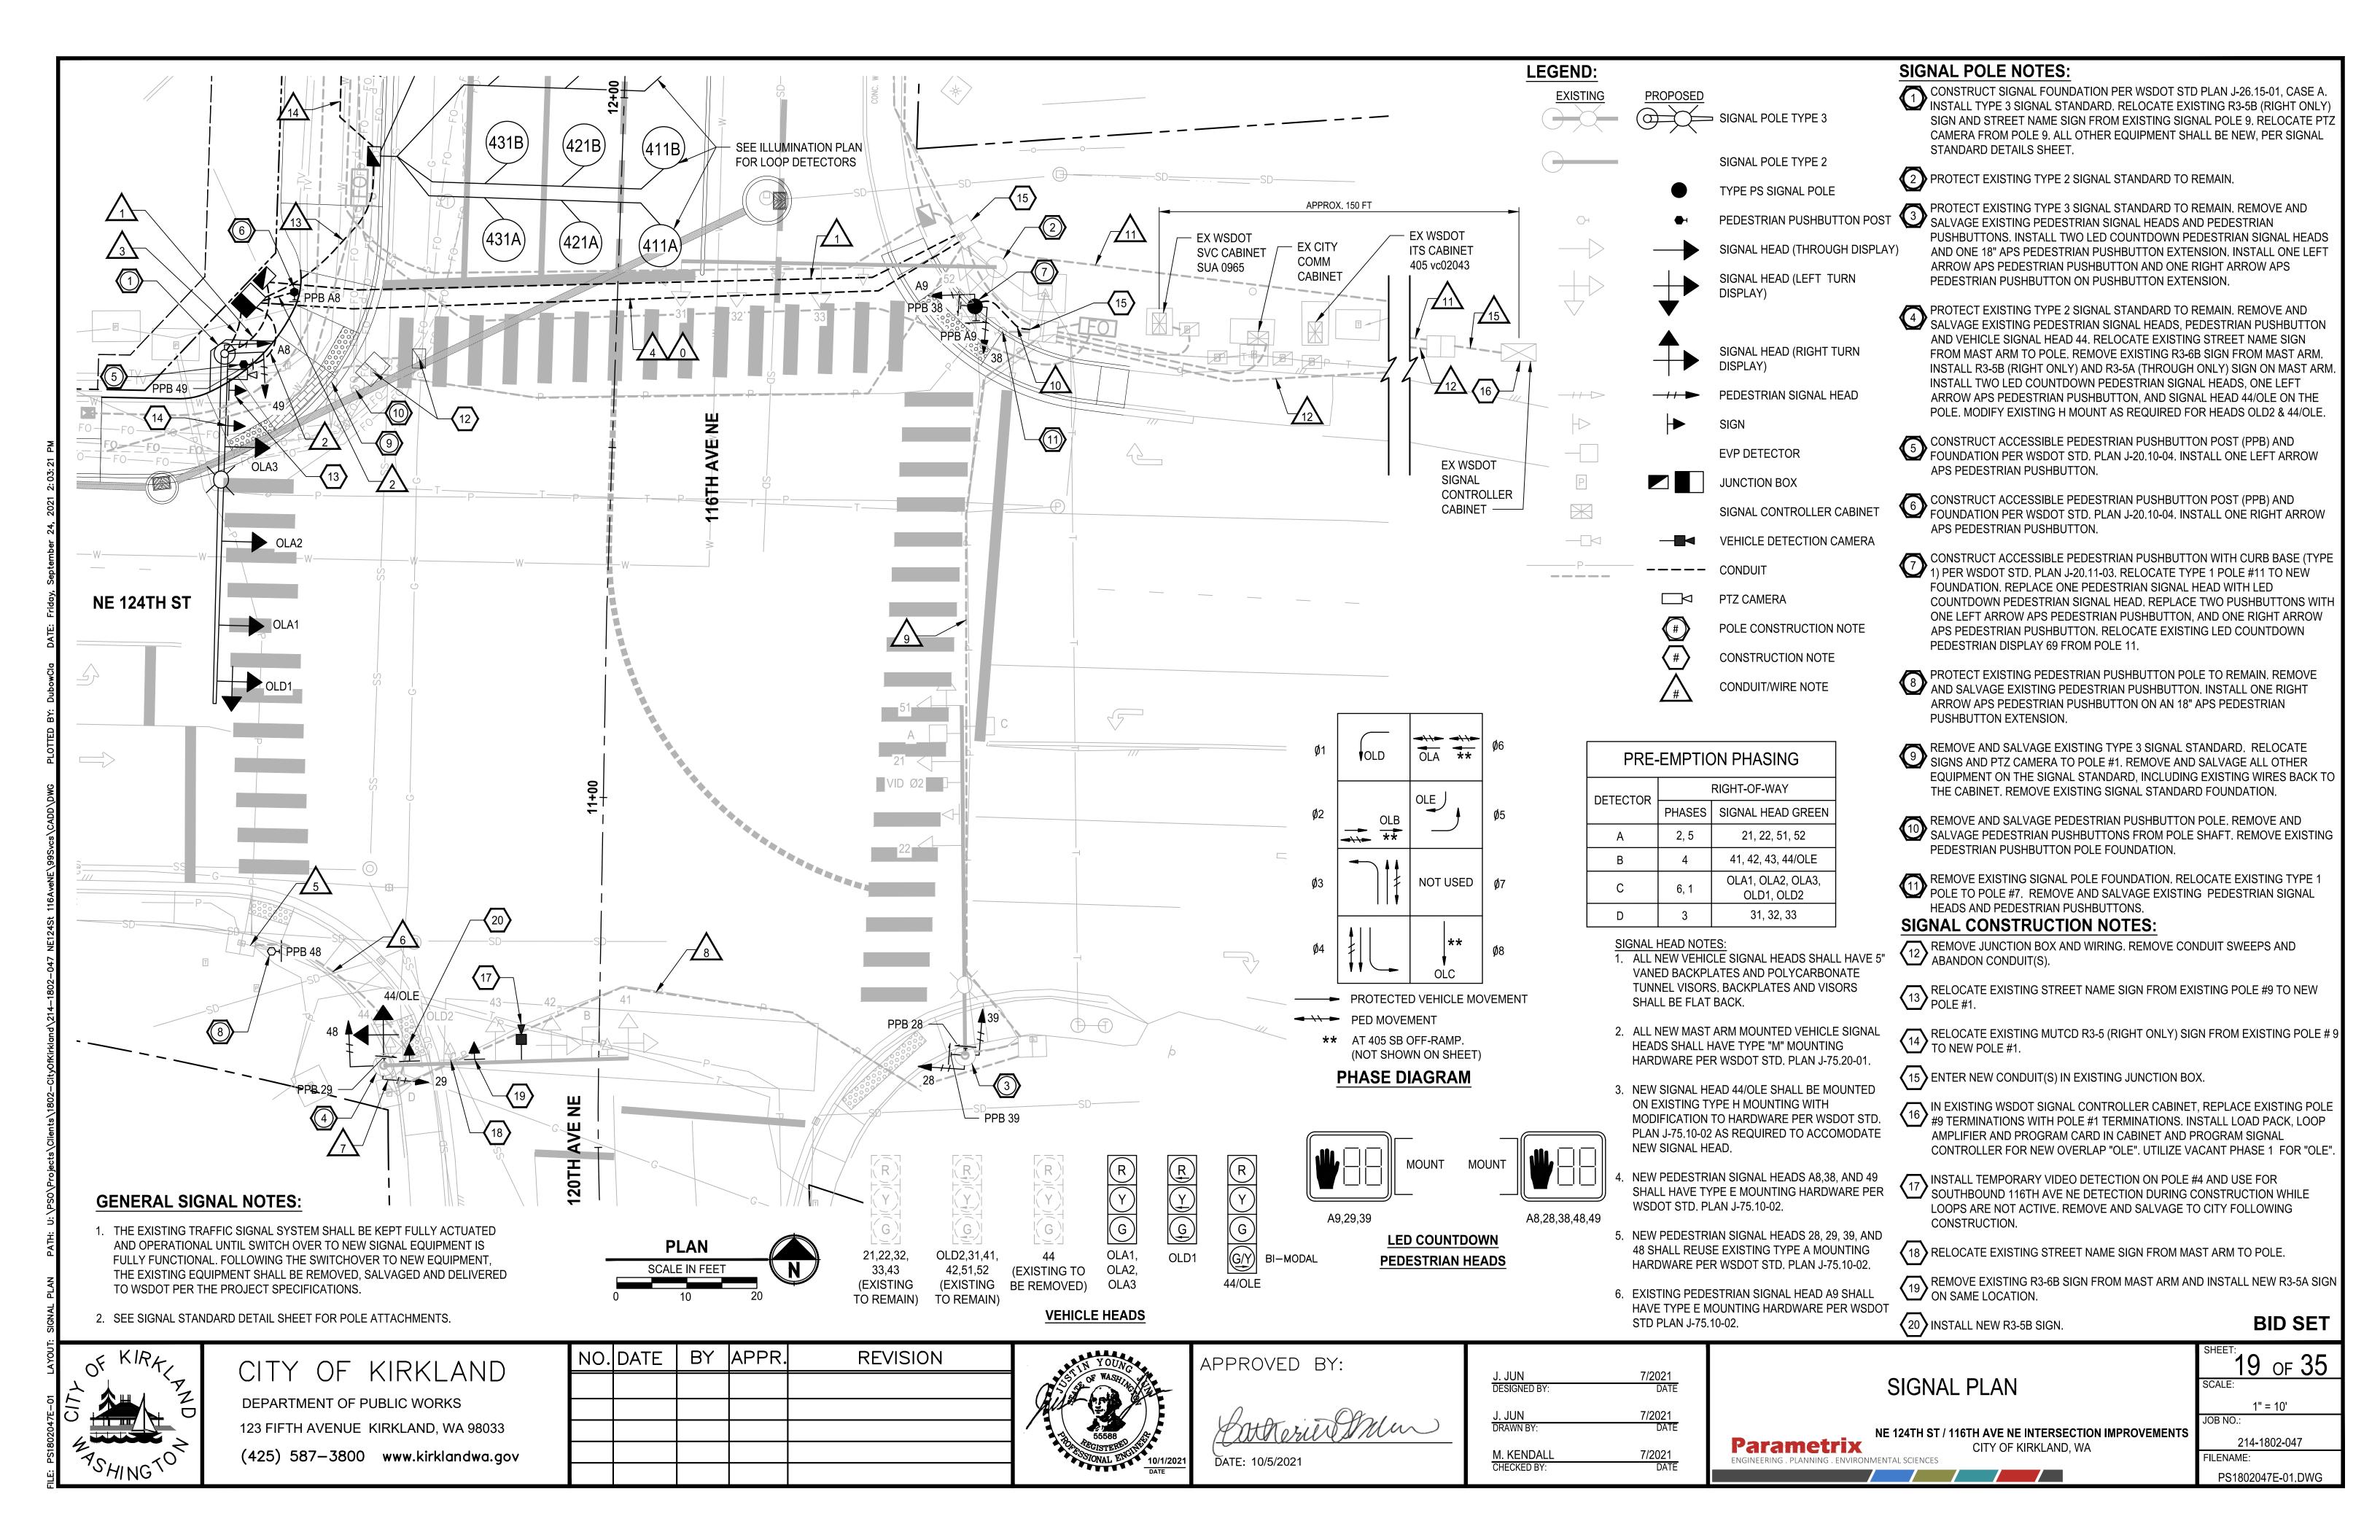

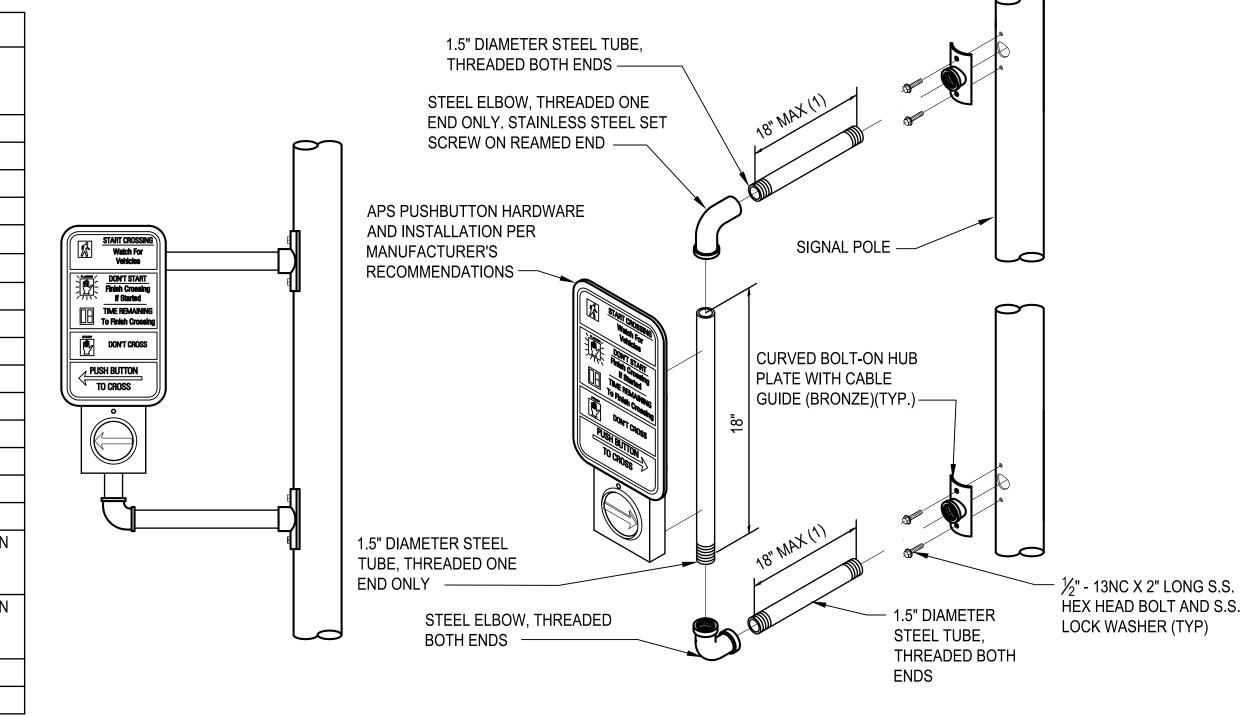

WIRE/CONDUIT SCHEDULE NOTES:

- 1. ALL CONDUITS CONTAINING CONDUCTORS SHALL INCLUDE A GROUND WIRE, NOT SHOWN IN THE WIRE/CONDUIT SCHEDULE. GROUND WIRE SHALL MATCH THE LARGEST CONDUCTOR (MIN. #8 UNLESS OTHERWISE NOTED).
- 2. WIRE/CONDUIT SCHEDULE INCLUDES ONLY CONDUIT RUNS THAT ARE MODIFIED AS PART OF THE SIGNAL MODIFICATIONS. ADDITIONAL EXISTING CONDUIT AND WIRE IS NOT SHOWN AND SHALL BE PROTECTED.
- 3. EXISTING WIRES SHOWN IN THE SCHEDULE ARE BASED ON CITY PROVIDED AS-BUILT PLANS AND FIELD INVENTORY. CONTRACTOR SHALL VERIFY EXISTING CONDUIT SHOWN IN THE SCHEDULE AND NOTIFY THE ENGINEER OF ANY DISCREPANCIES PRIOR TO PULLING NEW WIRE.
- 4. EXISTING SIAMESE CABLE COILED ON SIGNAL POLE OR IN JUNCTION BOX.
- [#] PROTECT EXISTING WIRE(S) TO REMAIN.
- (#) REMOVE EXISTING WIRE(S) AFTER CUTOVER TO NEW SIGNAL WIRE.
- {#} TEMPORARY WIRE TO BE REMOVED AFTER CUTOVER TO NEW DETECTION LOOPS.

APS PEDESTRIAN PUSHBUTTON EXTENSION NOTES:

- (1) EXTENSION LENGTH IS AS NOTED ON THE PLANS.
- (2) EXTENSION SHALL BE ORIENTED IN THE FIELD TOWARDS THE BACK OF LANDING AND TO MEET ACCESSIBILITY REACH REQUIREMENTS. COORDINATE ORIENTATION OF EXTENSION ON EXISTING POLE WITH ENGINEER IN THE FIELD PRIOR TO INSTALLATION.
- (3) APS PUSHBUTTON SHALL BE ORIENTED SO THE FACE OF THE BUTTON IS PARALLEL WITH THE DIRECTION OF THE CROSSWALK.
- (4) PUSHBUTTON SHALL FACE TOWARDS THE CENTER OF THE INTERSECTION UNLESS OTHERWISE NOTED.

K ALD WAS


CITY OF KIRKLAND


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NO.	DATE	BY	APPR.	REVISION	
					4





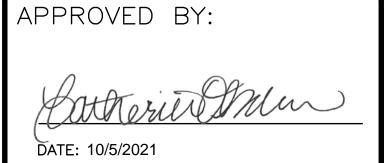

WIRE SCHEDULE AND DETAILS

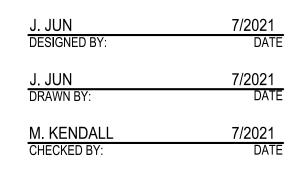NE 124TH ST / 116TH AVE NE INTERSECTION IMPROVEMENTS
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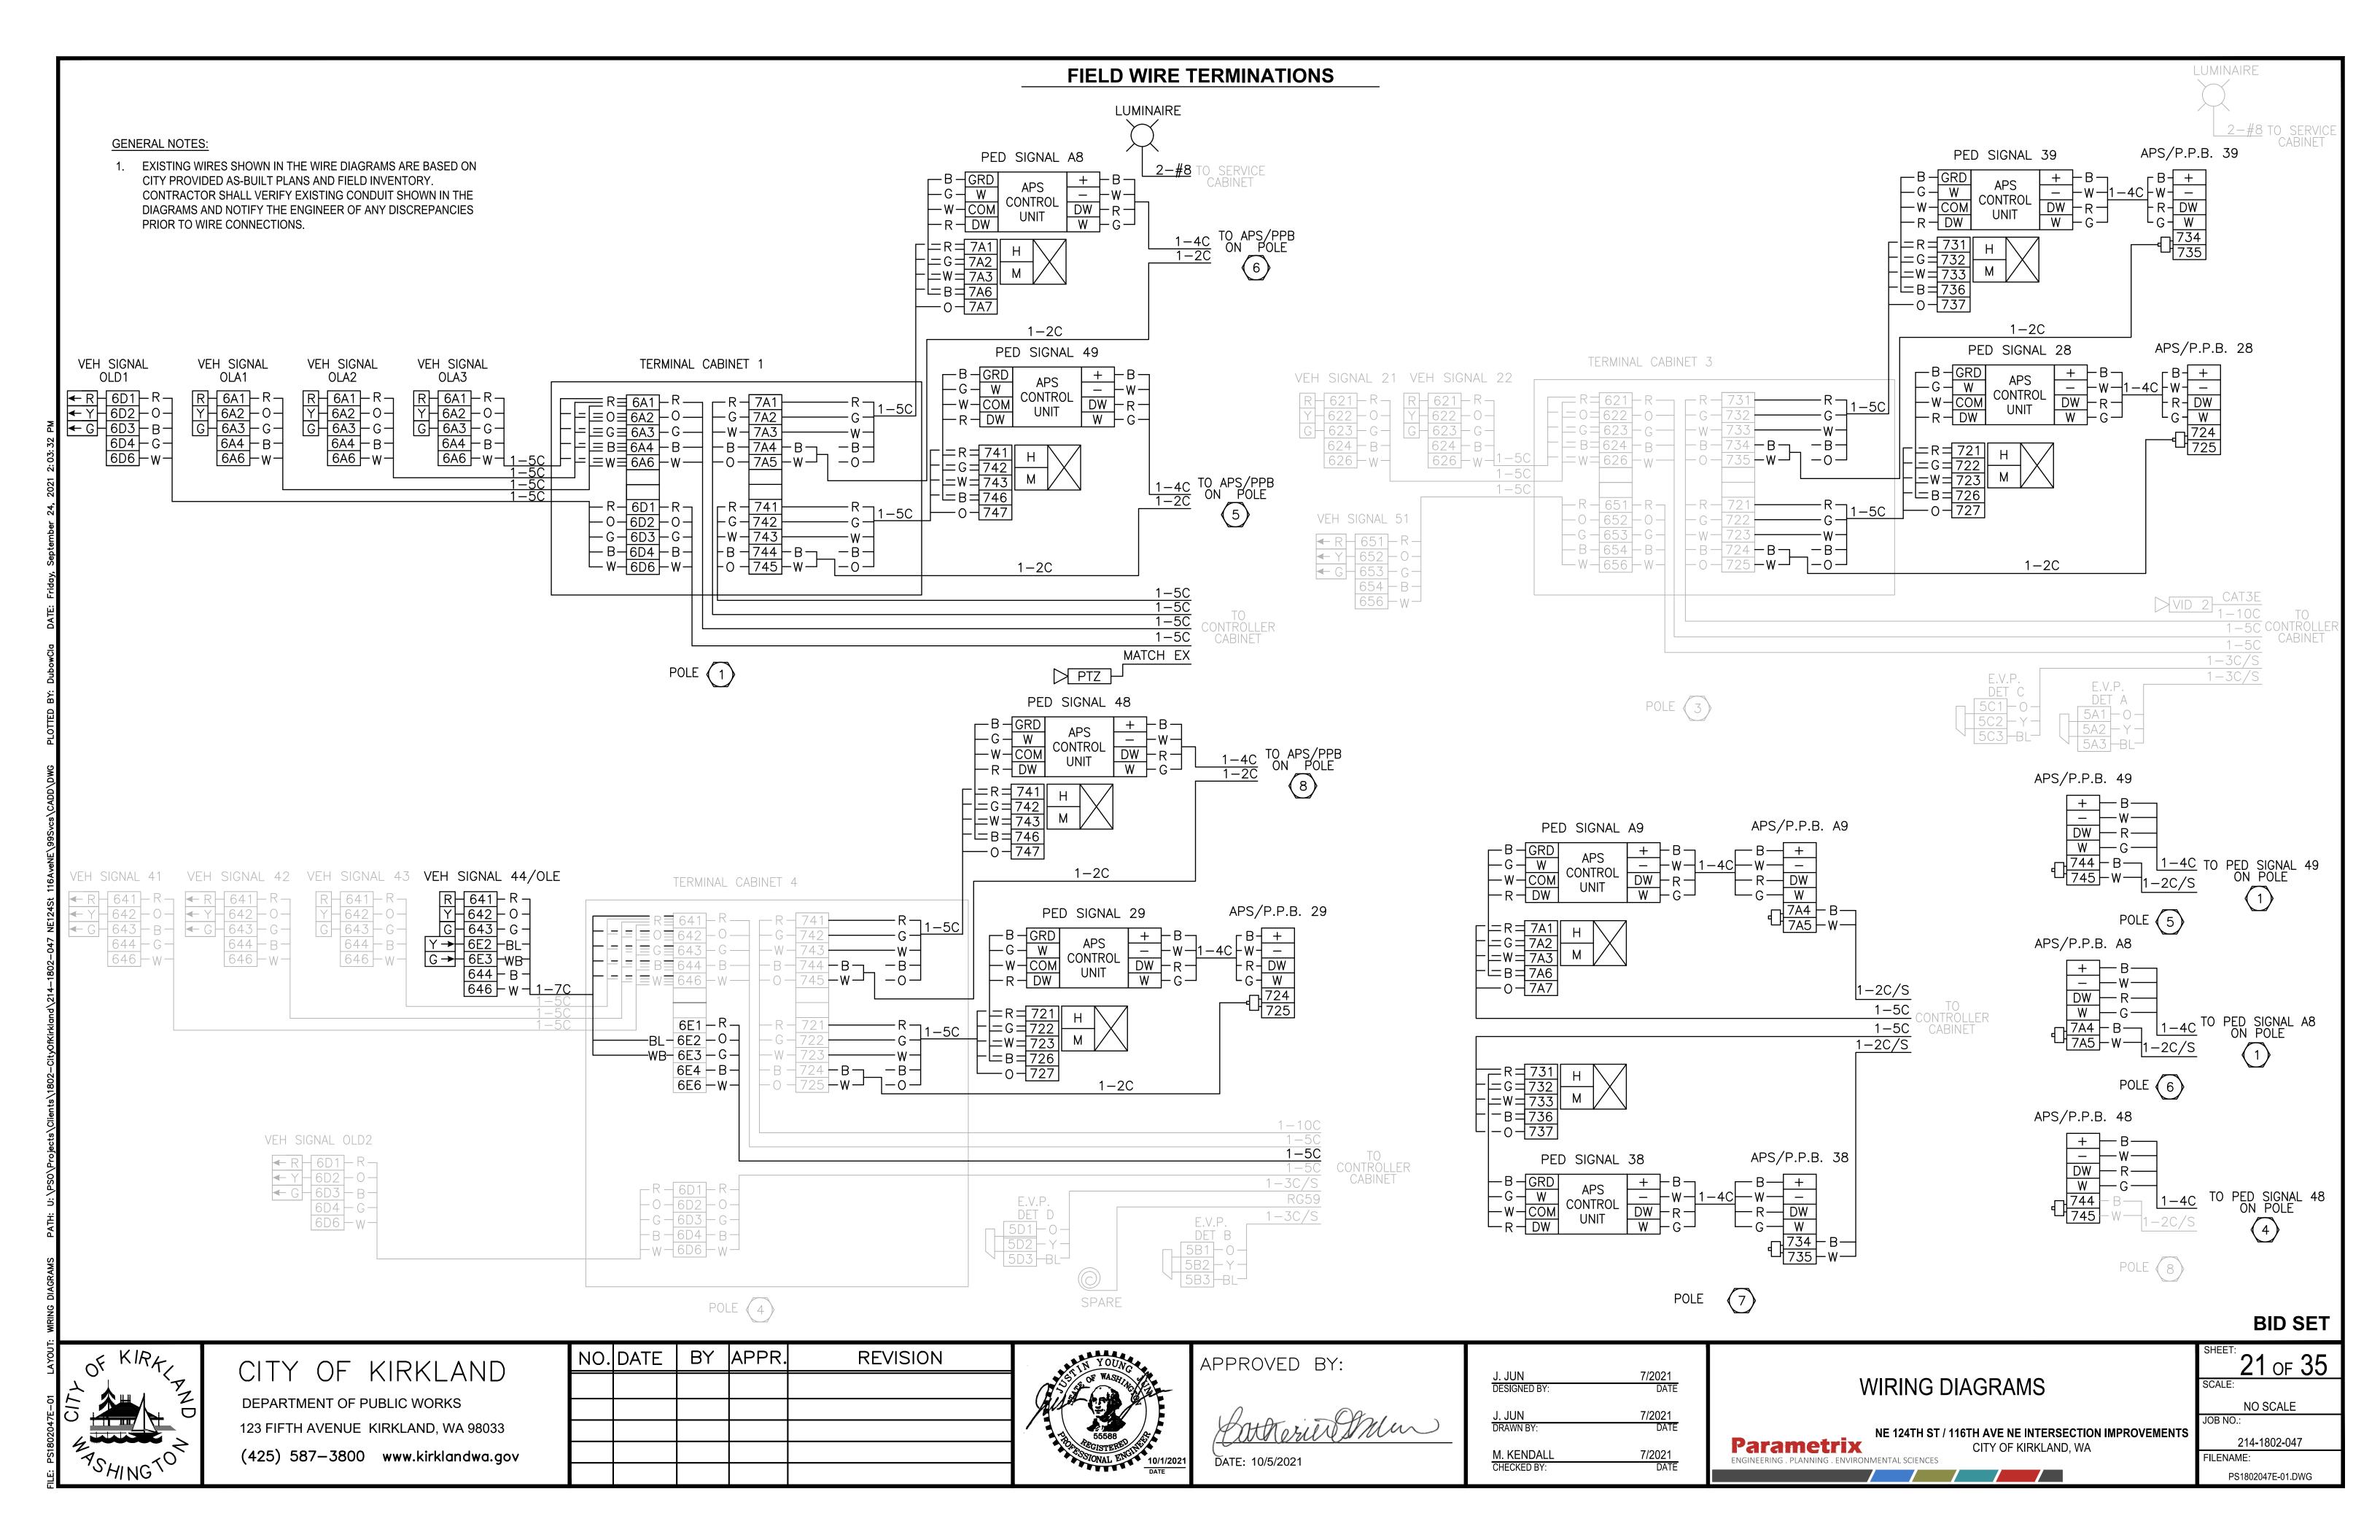
SHEET: 20 OF 35


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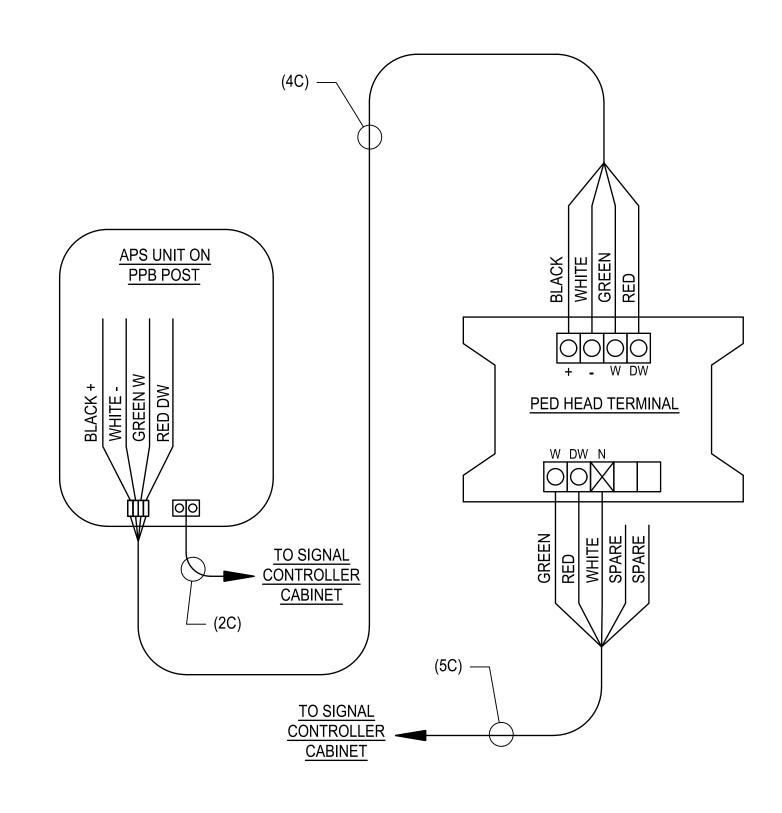
JOB NO.: 214-1802-047

FILENAME: PS1802047E-01.DWG

BID SET





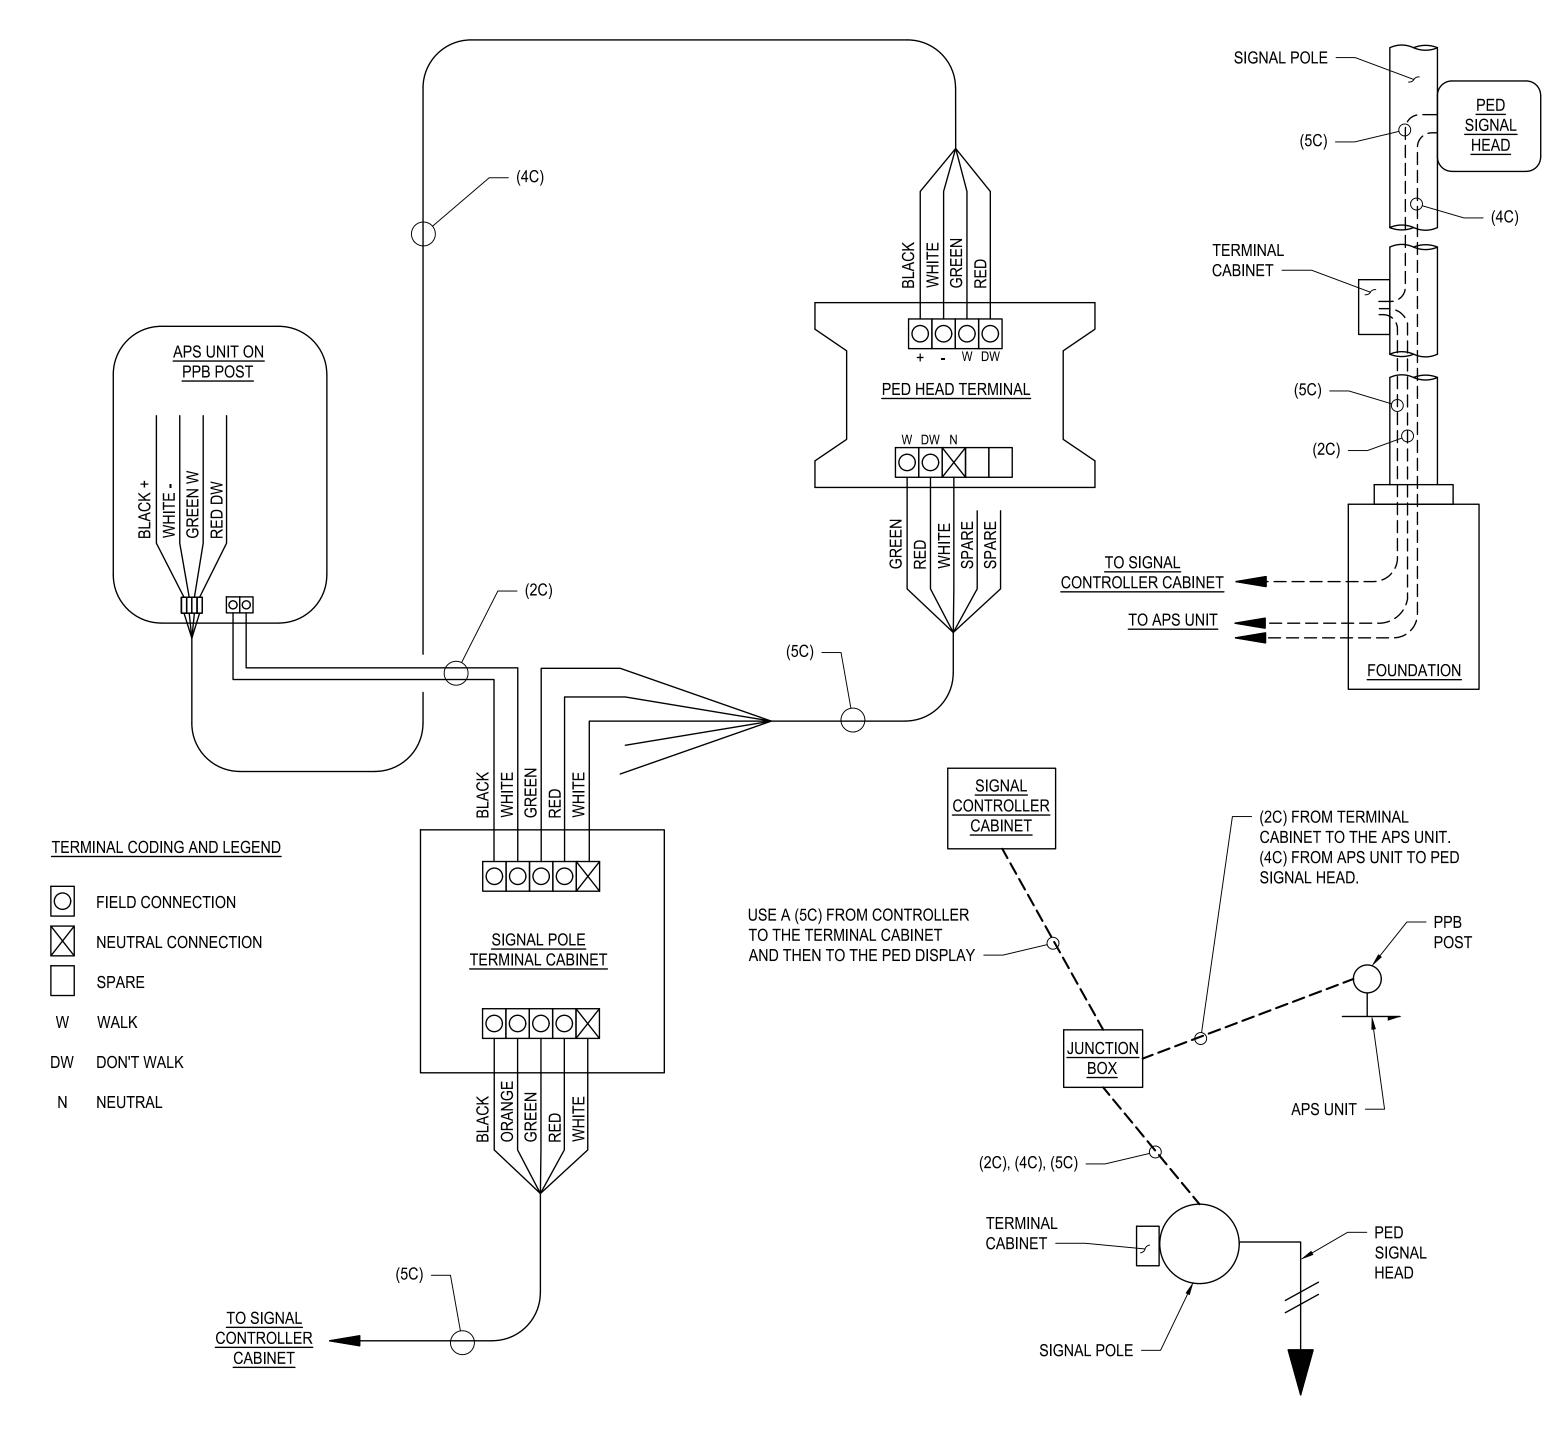

APS WIRING (WHEN NO TERMINAL CABINET)

DETAIL

NO SCALE

APS WIRING (PPB POST TO SIGNAL POLE TERMINAL CABINET)

DETAIL 1

NO SCALE

OF KIRA


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NO. DATE BY APPR. REVISION



APPROVED BY:

DATE: 10/5/2021

J. JUN	7/2021
DESIGNED BY:	DATE
J. JUN DRAWN BY:	7/2021 DATE
M. KENDALL	7/2021
CHECKED BY:	DATE

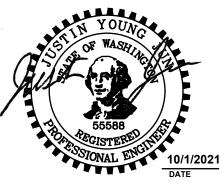WIRING DIAGRAMS

NE 124TH ST / 116TH AVE NE INTERSECTION IMPROVEMENTS
Parametrix CITY OF KIRKLAND, WA
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22 of 35
scale:


BID SET

JOB NO.:

214-1802-047

FILENAME:

PS1802047E-01.DWG

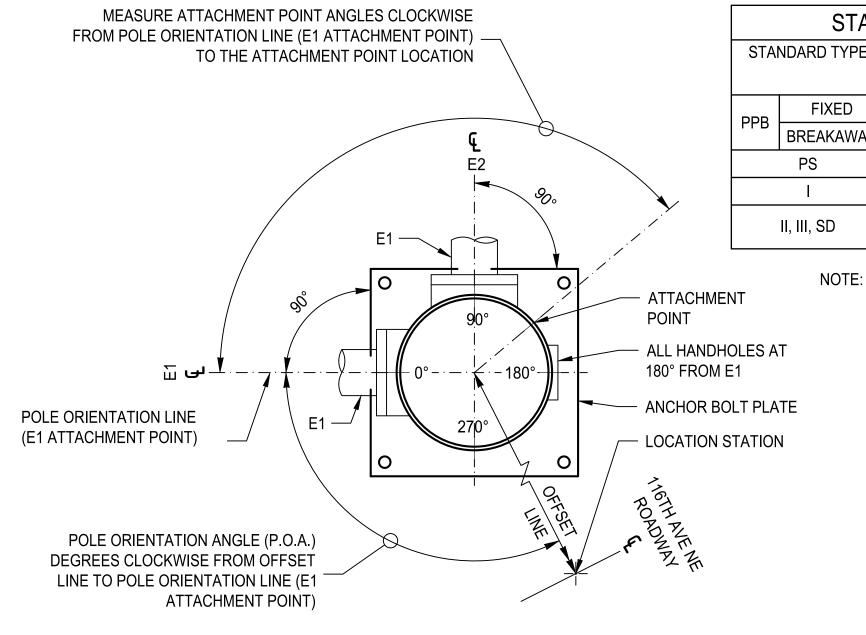

	STAN	3	LUMINAIRE N	^			
STA	NDARD TYPE	POLE	FOUNDA	ATION	ELECTRICAL	XYZ (F	-15)
			STANDARD	CURB		MAST ARM LENGTH	XYZ (F
חח	FIXED	J-20.10	J-20.10		J-20.10		40.0
PB	BREAKAWAY	J-20.15	J-20.15		J-20.15	6'	19.8
	PS PS	J-20.16	J-21.10	J-20.11	J-20.20	8'	26.4
	ı	J-21.15	J-21.10		J-21,20	10'	33.0
	'	0 21.10	J-26.10,		0 21.20	12'	39.6
	II, III, SD	N/A	J-26.10, J-26.15	N/A	N/A	14'	46.2
		16'	52.8				
	NOTE.						

RICAL	LUMINAIRE N XYZ (F	
	MAST ARM LENGTH	XYZ (FT ³)
.10	6'	19.8
.15	8'	26.4
.20	10'	33.0
.20	12'	39.6
4	14'	46.2
	16'	52.8
RATION		

ANCHOR BOLT DIMENSIONS AND CONFIGURATION SHALL BE PER POLE MANUFACTURER'S RECOMMENDATIONS FOR SIGNAL POLE WITH DECORATIVE BASE.

POLE ORIENTATION AND ATTACHMENT POINT DETAIL

LEGEND

a. VEHICLE DISPLAY

f. LUMINAIRE

i. APS PPB-M

k. PTZ CAMERA

b. MAST ARM MTD. SIGN

d. PRE-EMPT DETECTOR

g. PEDESTRIAN DISPLAY

h. TERMINAL CABINET


c. STREET NAME SIGN

e. POST MTD. SIGN

j. HANDHOLE

NOTE:

TYPE E MOUNTS SHALL BE USED FOR PEDESTRIAN DISPLAYS ON TYPE II OR III SIGNAL STANDARDS, WITH THE FOLLOWING EXCEPTION: PEDESTRIAN DISPLAYS MOUNTED ON OCTAGONAL (8 SIDED) SIGNAL STANDARDS AT AN ANGLE OTHER THAN A 45 DEGREE INCREMENT SHALL USE A TYPE A MOUNT FOR TWO PEDESTRIAN DISPLAYS, OR A TYPE B MOUNT FOR A SINGLE PEDESTRIAN DISPLAY.

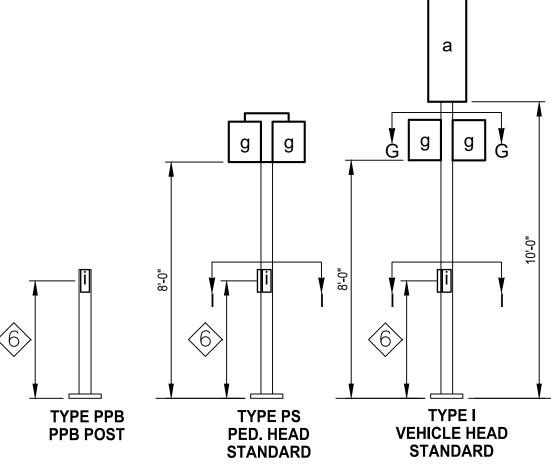


6 3' - 6" MEASURED FROM SIDEWALK SURFACE TO CENTER OF PEDESTRIAN PUSH BUTTON

NOTES


- MOUNTING COUPLING INSTALLED AT OFFSET DISTANCE INDICATED IN CHART. FOR TYPE N MOUNTS ONLY, DRILL 1" DIA. HOLE IN MAST ARM AND INSTALL PLASTIC SPLIT BUSHING FOR CABLE ENTRANCE.
- FIELD INSTALLED. SIGN SIZES SHALL NOT EXCEED THE MAXIMUM VALUES LISTED HERE:

SIGN	HEIGHT	WIDTH	AREA
b	3.0 FT	N/A	7.5 SQ. FT.
С	3.0 FT	N/A	36.0 SQ. FT.
е	N/A	3.0 FT	15.0 SQ. FT.

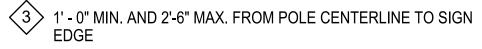

FOR POST MOUNTED SIGNS THERE SHALL BE 2' - 0" MIN. FROM THE FACE OF THE CURB OR THE EDGE OF THE SHOULDER TO THE EDGE OF THE SIGN



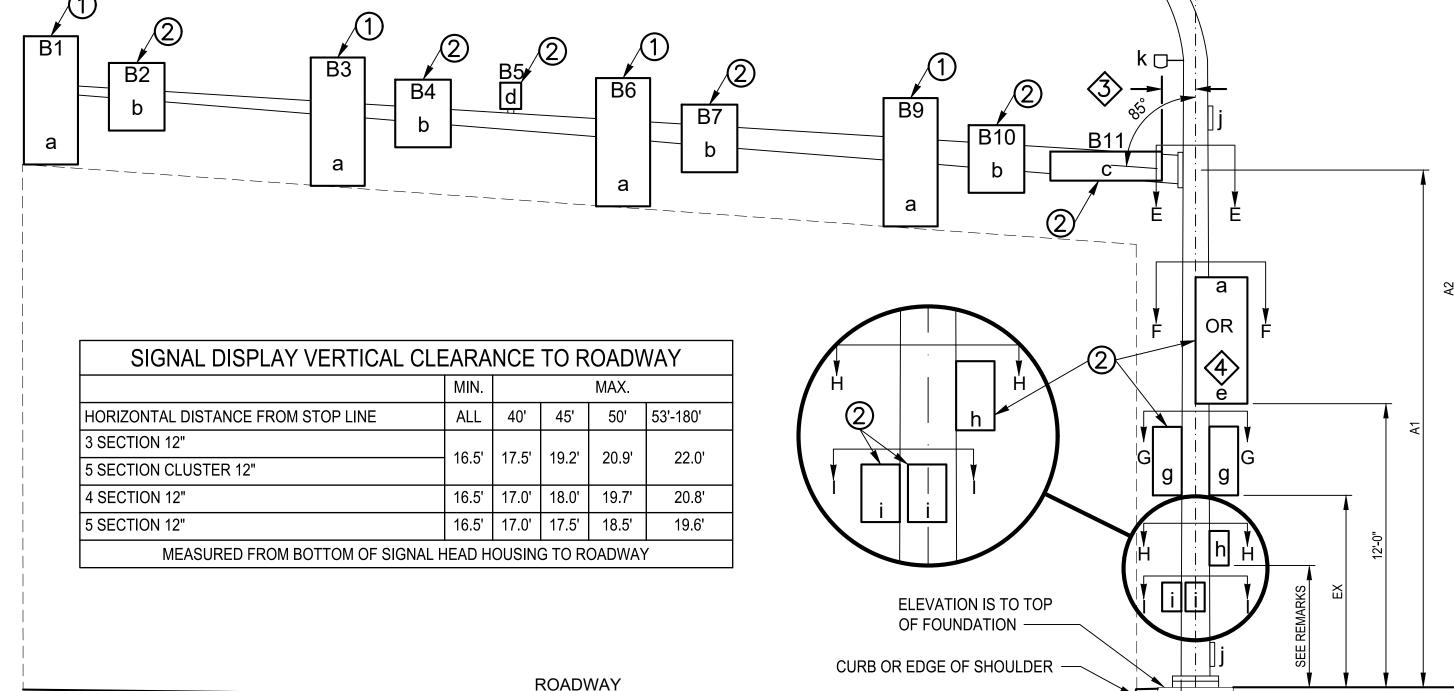

TYPE II, III & SD SIGNAL STANDARD

LIMITS OF VERTICAL CLEARANCE

5 PLACEMENT SHALL BE 2' - 0" MIN. FROM FACE OF CURB OR EDGE OF SHOULDER; 3' - 0" MIN. FROM FACE OF GUARDRAIL;

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4' - 0" MIN. FROM CONC. BARRIER TYPE 2 (MEASURED FROM A POINT WHERE THE BARRIER BASE MEETS THE SHOULDER SURFACE (TOE). MEASUREMENT TAKEN FROM TRAFFIC SIDE OF BARRIER; TO FACE OF POLE)

7											SI	GNAL S	TANDA	ARD D	ETAIL	CHAR	T - NE '	124TH S	ST & 116	STH AVE	E NE INTEI	RSECTION													
STD. NO.	ROADWAY		FIELD LOCATI	ON	РО		HEIGHT	0.5		015 - 70 4	TT4 OLUME			ARM DA	λTA	NAMES IN COLUMN 1	AD ADEA	AO (FT ²) (V)	200		LUMINAIRE - ARM (FT)	CALCULATED POLE XYZ		POl	E ATTA	ACHMENT F	OINT AN	GLES (d	• ,	SOIL BEARING		NDATION (FT)	DEPTH	REMARKS	
# CI	ENTERLINE	STATION	OFFSET (FT) LT	RT ELEV.		PE LENGT (FT)	A1 A2	B1 B2	FSETS (FT) (Z) (F					B1	B2 B3			AS (FT ²) (X) B7 B8		310 B11	C	**	D	E	·1(1)	F2(2) G1	G2	Н	l1 l2	PRESSURE (PSF)	3' RD	3' SQ	4' RD)	
1 11	6TH AVE NE	11+61.5	55.8 X	*	90° II	50	18.5 40	46.8	38.8	26.8		13.3 10	0.3 5.2	9.2	9.2	2	9.2	2	9.2	7.5 11(4)	16	1345	0°	0°		180	^{265°}	180°		1000	11	9	9		
2 11	6TH AVE NE	EX	EX	EX	359°(EX)							EXISTIN	NG POLE	TO REM	IAIN. NO C	CHANGE.							EX	EX	EX			EX		N/A	EX	EX	EX		
3 110	6TH AVE NE	EX	EX	EX	89°(EX) II							EXISTIN	NG POLE	TO REM	IAIN. NO C	CHANGE.							EX	EX		EX	EX	EX	3°(3)(5) 93°(3)	N/A	EX	EX	EX		
4 11	6TH AVE NE	EX	EX	EX	357°(EX)	EX. PO	LE TO REMAIN.	EX EX	EX	EX	13.0	3	.8	EX	EX EX		EX	7.5		7.5		++	EX	EX	EX	270 EX	EX	EX	273°(3)	N/A	EX	EX	EX		
5 11	6TH AVE NE	11+60.1	53.0 X	*	50° PP	В																							307°(3)						
6 11	6TH AVE NE	11+70.7	46.1 X	*	20° PP	В																							68°(3)						
7 11	6TH AVE NE	11+71.9	51.1	X *	310° I																					134	² 231°		51°(3) 314°(3)						
8 11	6TH AVE NE	EX	EX	EX	289°(EX) PP	В																							73°(3)	N/A	EX	EX	EX		
110	6TH AVE NE	14+69.0	47.0 X	EX	0° II	55	18.5 40	52.5	42.0		30.5	20	0.0		16	8		7.5		7.5	16	1608								1000	15	10	10		

- * CONSTRUCT FOUNDATION LEVEL WITH TOP OF PROPOSED GRADE. ** CALCULATED POLE XYZ (FT³) IS THE SUM OF THE TOTAL XYZ (FT³) FOR THE SIGNAL ARM AND THE XYZ (FT³) FOR
- THE LUMINAIRE ARM (IF PRESENT).
- OVERHEAD SIGN STRUCTURE.
- EXISTING CALCULATED POLE XYZ (FT³) IS APPROXIMATELY 1325 FT³ (BASED ON ASSUMED Z VALUES). PROPOSED CALCULATED POLE (4) ASSUMED STREET NAME SIGN SIZE.

 XYZ (FT³) WITH NEW SIGNS IS APPROXIMATELY 1328 FT³ (BASED ON ASSUMED Z VALUES). ASSUMED EXISTING FOUNDATION DESIGN IS (5) APS PEDESTRIAN PUSHBUTTON ON 18" APS PUSHBUTTON EXTENSION. BASED ON XYZ VALUE OF 1350 PER WSDOT STANDARD. EXISTING FOUNDATION WILL ACCOMMODATE MAST ARM WITH NEW SIGNS.
- (1) F1 POLE ATTACHMENT POINT ANGLE REFERS TO SIGNAL HEADS.
- (2) F2 POLE ATTACHMENT POINT ANGLE REFERS TO SIGNS.
- (3) FIELD VERIFY AND ADJUST AS NECESSARY AND AS APPROVED BY THE ENGINEER TO ORIENT THE BUTTON FACE TO BE PARALLEL WITH DIRECTION OF CROSSING.
 - (4) ASSUMED STREET NAME SIGN SIZE.

REVISION

BY APPR.

NO. DATE

BID SET



CITY OF KIRKLAND

DEPARTMENT OF PUBLIC WORKS

123 FIFTH AVENUE KIRKLAND, WA 98033 (425) 587-3800 www.kirklandwa.gov

SO OF WASHING	
ARGISTERED NEW SOLONAL ENGINE	10/1/2
ALTER.	DATE

APPROVED BY:

DATE: 10/5/2021

7/2021 DATE 7/2021 DATE 7/2021 DATE M. KENDALL

SIGNAL STANDARD DETAILS

NE 124TH ST / 116TH AVE NE INTERSECTION IMPROVEMENTS **Parametrix** CITY OF KIRKLAND, WA

23 of 35 NO SCALE


214-1802-047 FILENAME: PS1802047E-01.DWG


				WIRE S	SCHEDULE
Run No.	Ex. Conduit	New Conduit	Existing Conductors	New Conductors	Notes
	4"		72SMFO		
1			36 SMFO		
	4"				Spare; Conduit to be intercepted See construction note 8
2	2"		12SMFO		
2	2		12SMFO		
3	3"		12SMFO		
	3		12SMFO		
4	2"		12SMFO		
			12SMFO		
5	3"		12SMFO		
			12SMFO		
	411		48SMFO		
6	4"		36SMFO		
O			12SMFO		
	4"				Spare
	4"		48SMFO		
7			48SMFO		Chara
	4"			72SMFO	Spare Intercepted Conduit See Construction note 8
8		4"		36 SMFO	Intercepted Conduit See Construction note 8
		- 11		12SMFO	
9		4"		12SMFO	
		4"			Spare
10		3"		12SMFO	
10				12SMFO	
		4"		48SMFO	
11		4"		36SMFO	
		4"		12SMFO	Sparo
				48SMFO	Spare Intercepted Conduit See Construction note 14
12		4"		48SMFO	Intercepted Conduit See Construction note 14
		_		12SMFO	intercepted conduit see construction note 14
13		3"		12SMFO	

1	WIRE SCHEDULE
\' /	SCALE: N/A

CITY OF KIRKLAND DEPARTMENT OF PUBLIC WORKS 123 FIFTH AVENUE KIRKLAND, WA 98033 (425) 587-3800 www.kirklandwa.gov

NO.	DATE	BY	APPR.	REVISION

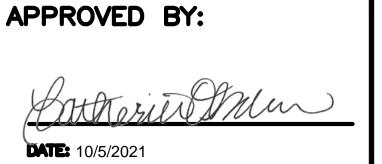

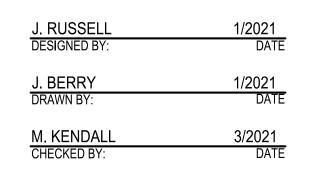

CONSTRUCTION NOTES:

- EXISTING FIBER VAULT (FOV-1) WITH EXISTING SPLICE **ENCLOSURE**
- EXISTING SPLICE CLOSURE IN TYPE 2 JUNCTION BOX (CV-02); JUNCTION BOX TO BE REPLACED WITH CABLE VAULT, SEE ITS02 PLACEMENT. FIELD VERIFY PLACEMENT.
- EXISTING TYPE 8 SIGNAL/ITS JUNCTION BOX
- CITY OF KIRKLAND COMMUNICATIONS CABINET WITH ITS CABINET ATTACHED.
- EXISTING SPLICE CLOSURE IN 25-TA VAULT (CV-01); VAULT TO BE RELOCATED TO NEW POSITION, SEE ITS02 PLACEMENT. FIELD VERIFY PLACEMENT.
- EXISTING FIBER OPTIC VAULT (FOV-2) WITH EXISTING SPLICE ENCLOSURE; ADDITIONAL COORDINATION REQUIRED WITH WSDOT FOR ACCESS TO VAULT.
- NEW CITY OF KIRKLAND CABLE VAULT (CV-02)
- INTERCEPT EXISTING 4" SPARE CONDUIT AND EXTEND TO NEW CITY OF KIRKLAND CABLE VAULT (CV-02)
- FIELD VERIFY EXISTING SPLICE MAKEUP. REPLICATE EXISTING SPLICES LOCATED IN THE EXISTING CABLE VAULT CV-02 IN THE RELOCATED CABLE VAULT SPLICE CLOSURE CV-02. THE 72 STRAND FIBER OPTIC CABLE WILL SPLICE TO ONE OF THE (1) 48 STRAND CABLES AND (1) 12 STRAND CABLE. CONTRACTOR IS RESPONSIBLE TO ACCOMMODATE ALL REQUIRED SPLICING AT THIS LOCATION.
- FURNISH AND INSTALL NEW CITY OF KIRKLAND CABLE VAULT (CV-03)
- RETERMINATE NEW (2) 12 STRAND FIBER OPTIC CABLES TO EXISTING FIBER OPTIC DISTRIBUTION PANEL. FIELD VERIFY CABLE/PANEL TERMINATION LOCATION. COORDINATE TERMINATION/OUTAGE WITH CITY OF KIRKLAND IT DEPARTMENT
- FURNISH AND INSTALL SPLICE CLOSURE AND SPLICE NEW FIBER OPTIC CABLE AS INDICATED IN SPLICE DETAIL 1 ON SHEET ITS03
- FURNISH AND INSTALL SPLICE CLOSURE AND SPLICE NEW FIBER OPTIC CABLE AS INDICATED IN SPLICE DETAIL 2 ON SHEET ITS03
- FURNISH AND INSTALL NEW CITY OF KIRKLAND CABLE VAULT
- INTERCEPT EXISTING 4" SPARE CONDUIT AND EXTEND TO NEW CITY OF KIRKLAND CABLE VAULT (CV-02)
- 16 PULL BACK FIBER OPTIC CABLE FROM EXISTING CABLE VAULT (CV-01) TO EXISTING FIBER VAULT (FV-02). RE-INSTALL FIBER OPTIC CABLE TO RELOCATED CABLE VAULT (CV-01)
- PULL BACK EXISTING 48SMFO TO FOV-02 AND RE-INSTALL INTO NEW CABLE VAULT (CV-01)




ITN01 - FIBER OPTIC RELOCATION NOTES AND SCHEDULE


NE 124TH ST / 116TH AVE NE INTERSECTION IMPROVEMENTS CITY OF KIRKLAND, WA


24 of 34 NO SCALE 214-1802-047

Parametrix


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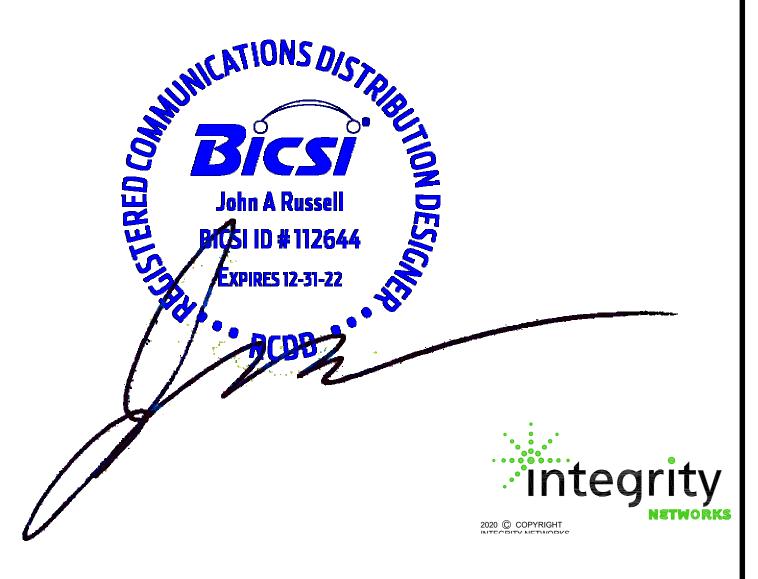


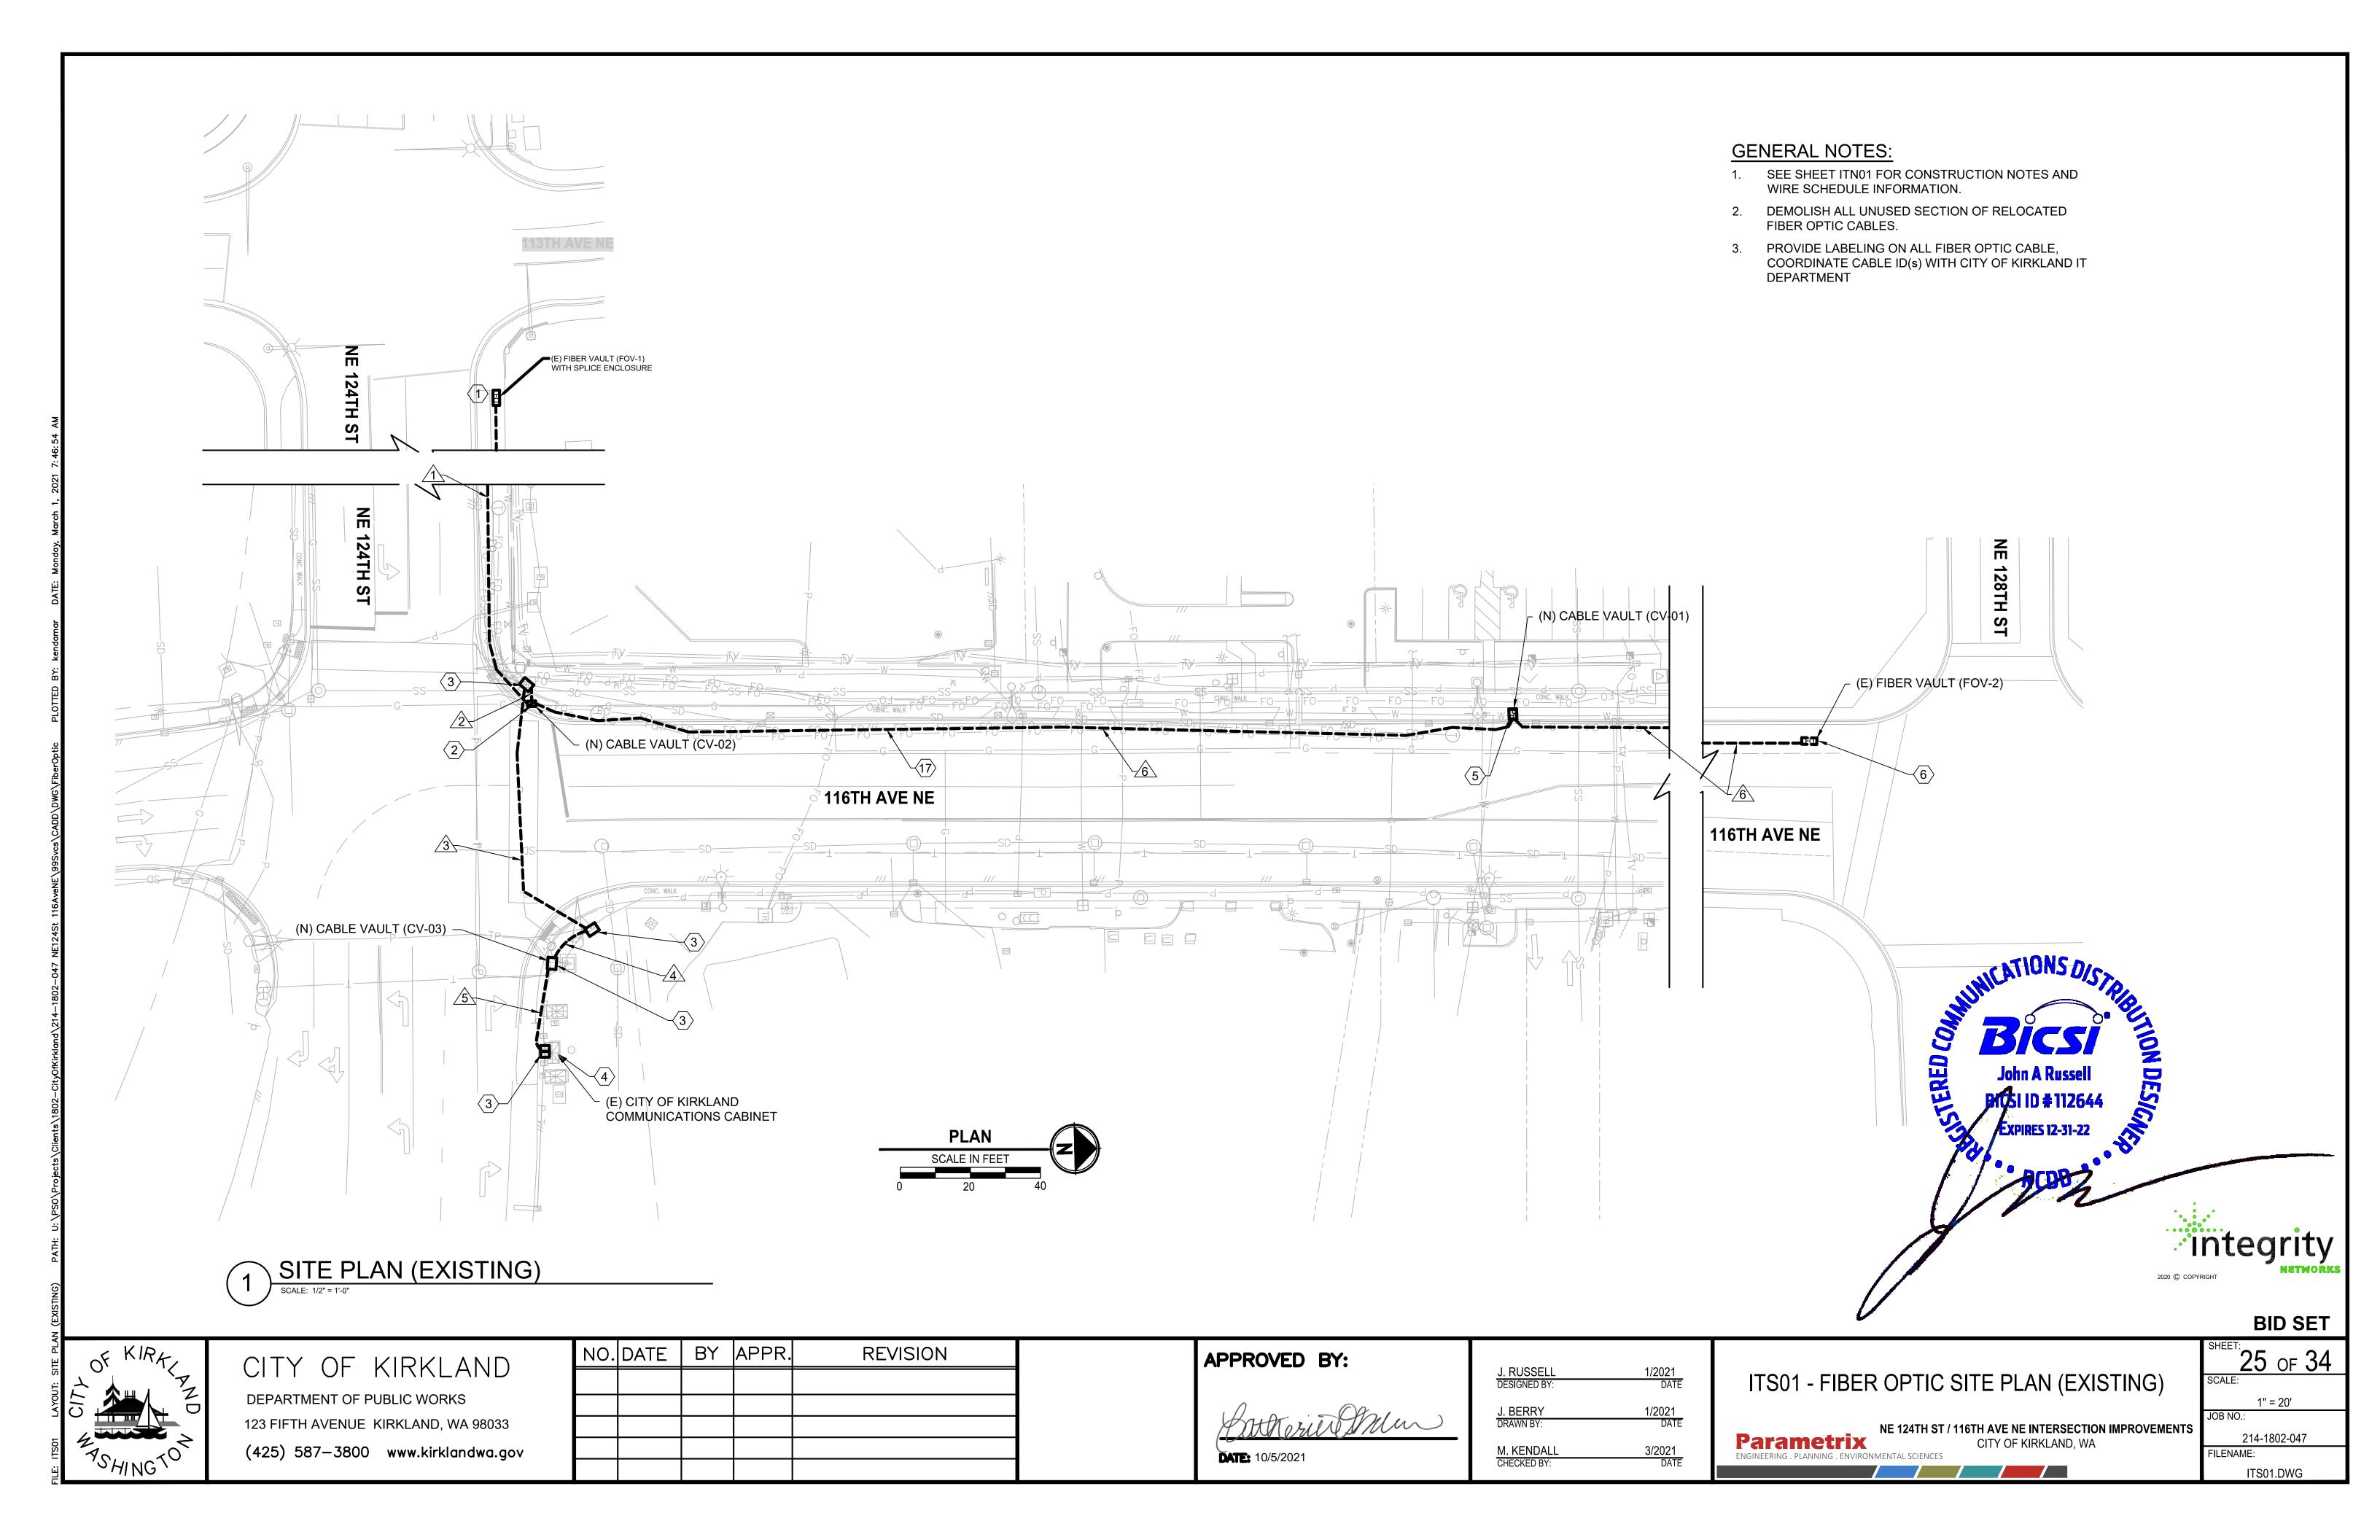

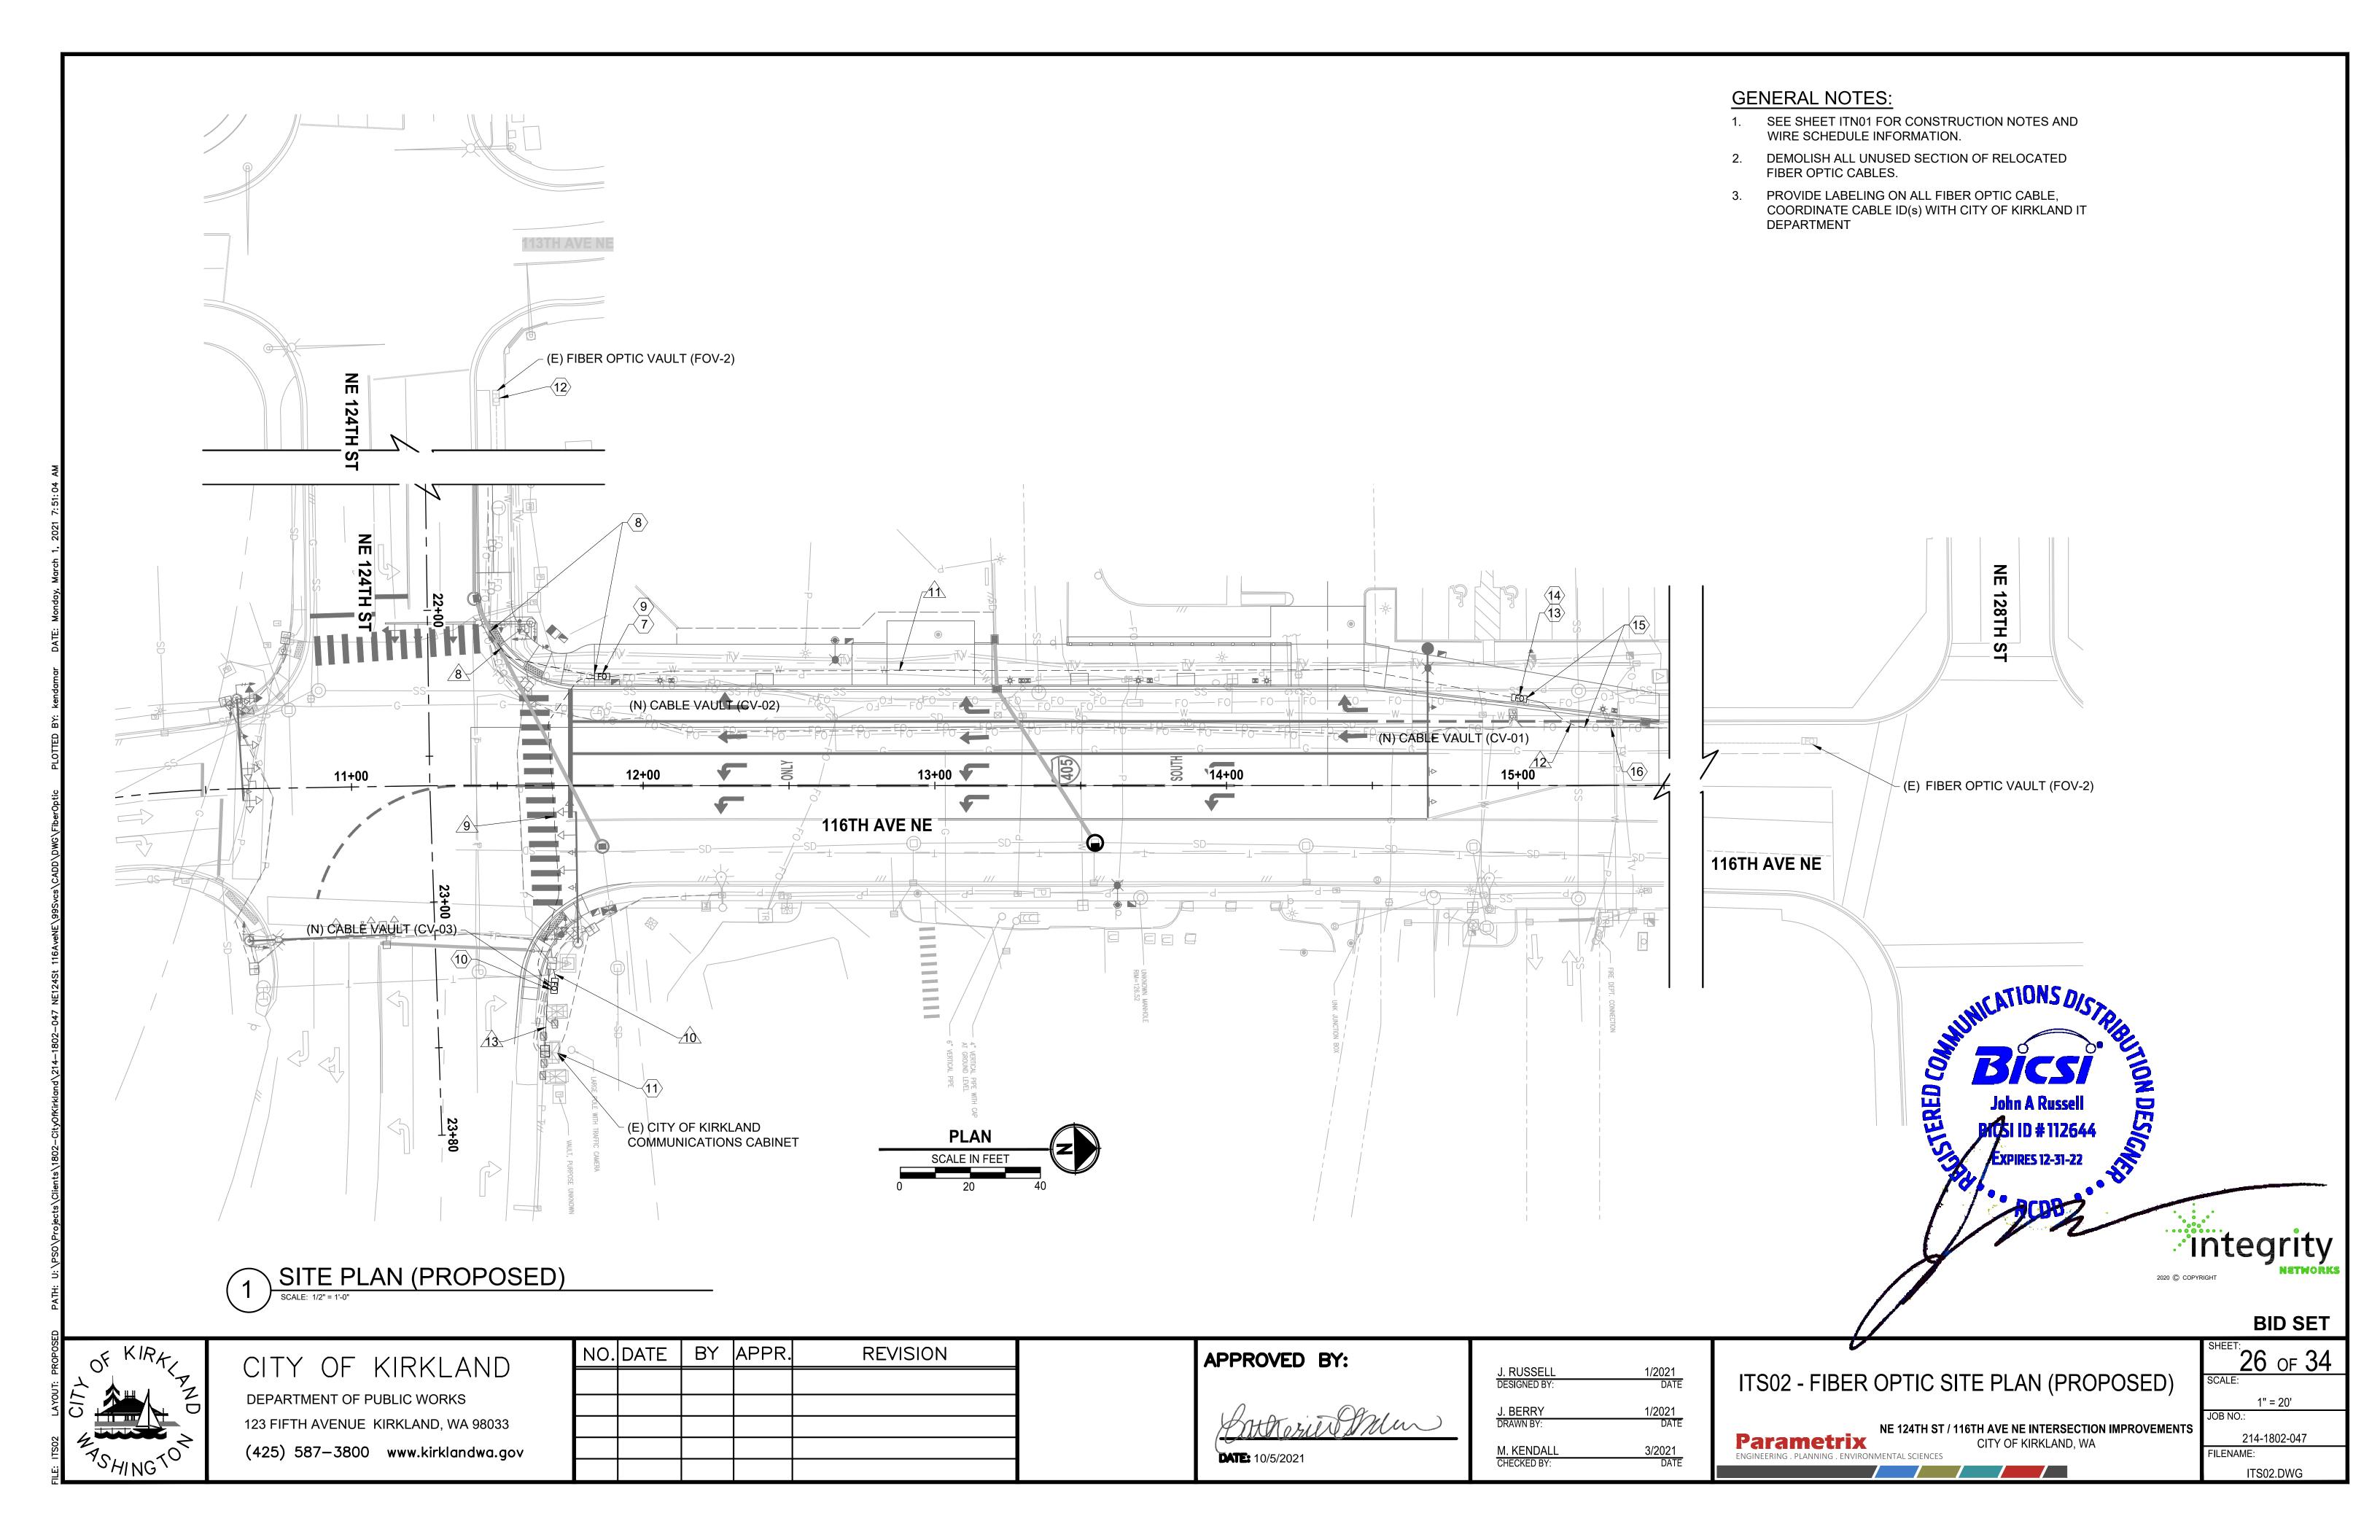SPLICE DETAIL AT FOV-01 SCALE: N/A

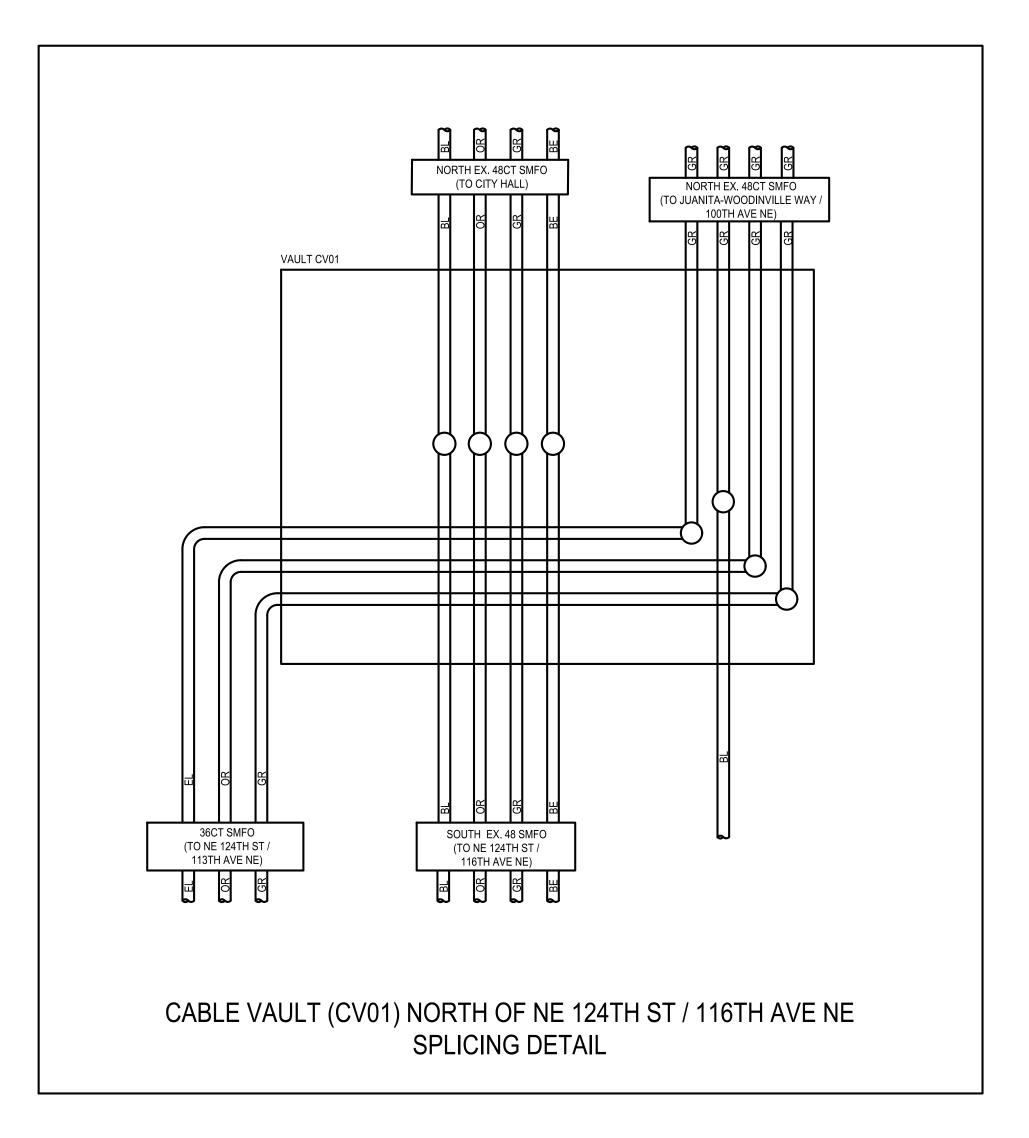GENERAL NOTES:

- SEE SHEET ITN01 FOR CONSTRUCTION NOTES AND WIRE SCHEDULE INFORMATION.
- 2. DEMOLISH ALL UNUSED SECTION OF RELOCATED FIBER OPTIC CABLES.
- 3. PROVIDE LABELING ON ALL FIBER OPTIC CABLE, COORDINATE CABLE ID(s) WITH CITY OF KIRKLAND IT DEPARTMENT

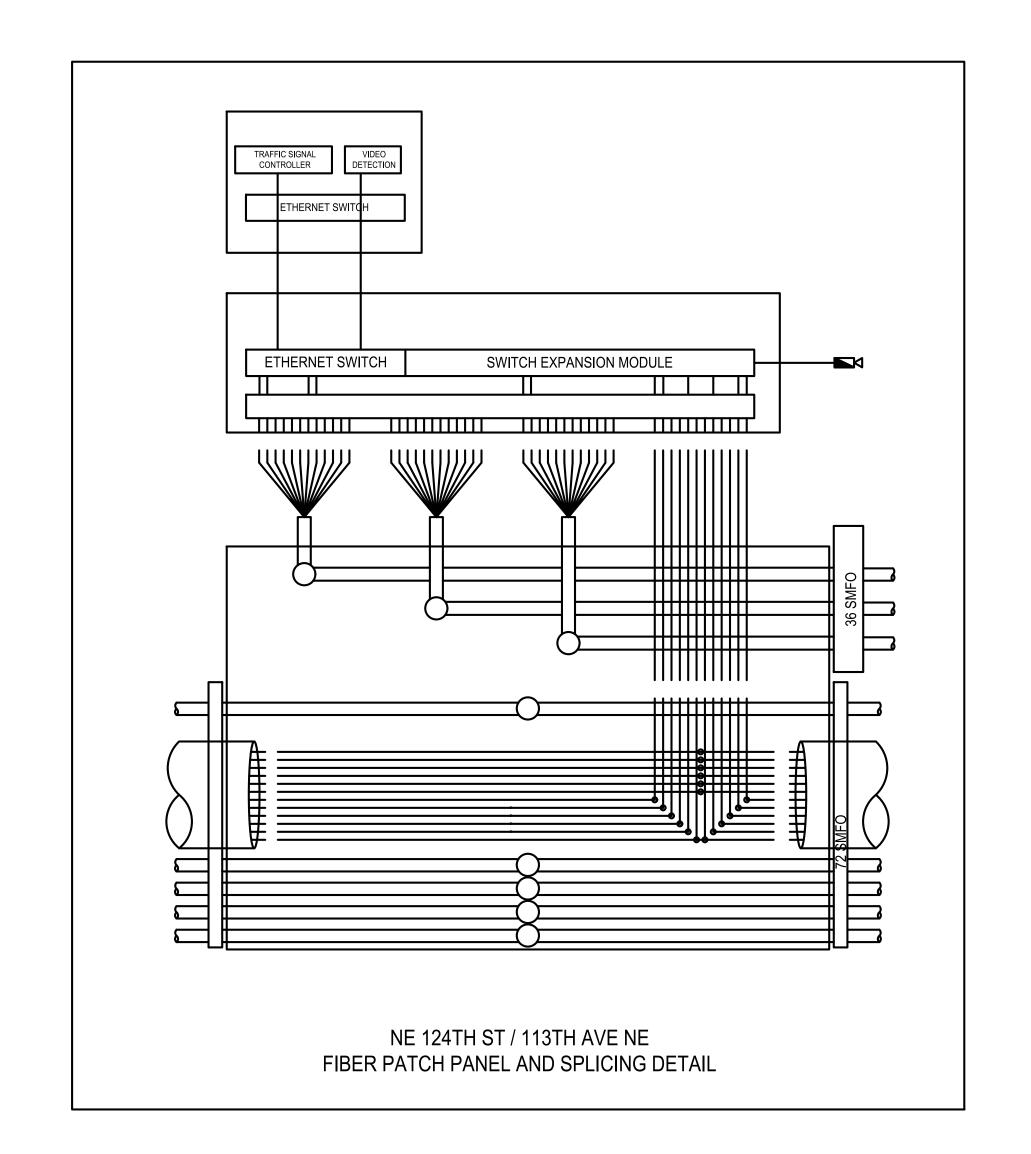

BID SET



CITY OF KIRKLAND

DEPARTMENT OF PUBLIC WORKS

123 FIFTH AVENUE KIRKLAND, WA 98033

(425) 587–3800 www.kirklandwa.gov

NO. DATE BY APPR. REVISION

APPROVED BY:

DATE: 10/5/2021

 J. RUSSELL
 1/2021

 DESIGNED BY:
 DATE

 J. BERRY
 1/2021

 DRAWN BY:
 DATE

 M. KENDALL
 1/2021

 CHECKED BY:
 DATE

ITS03 - FIBER OPTIC SPLICE DETAILS

Parametrix

NE 124TH ST / 116TH AVE NE INTERSECTION IMPROVEMENTS

CITY OF KIRKLAND, WA

27 OF 34

SCALE:


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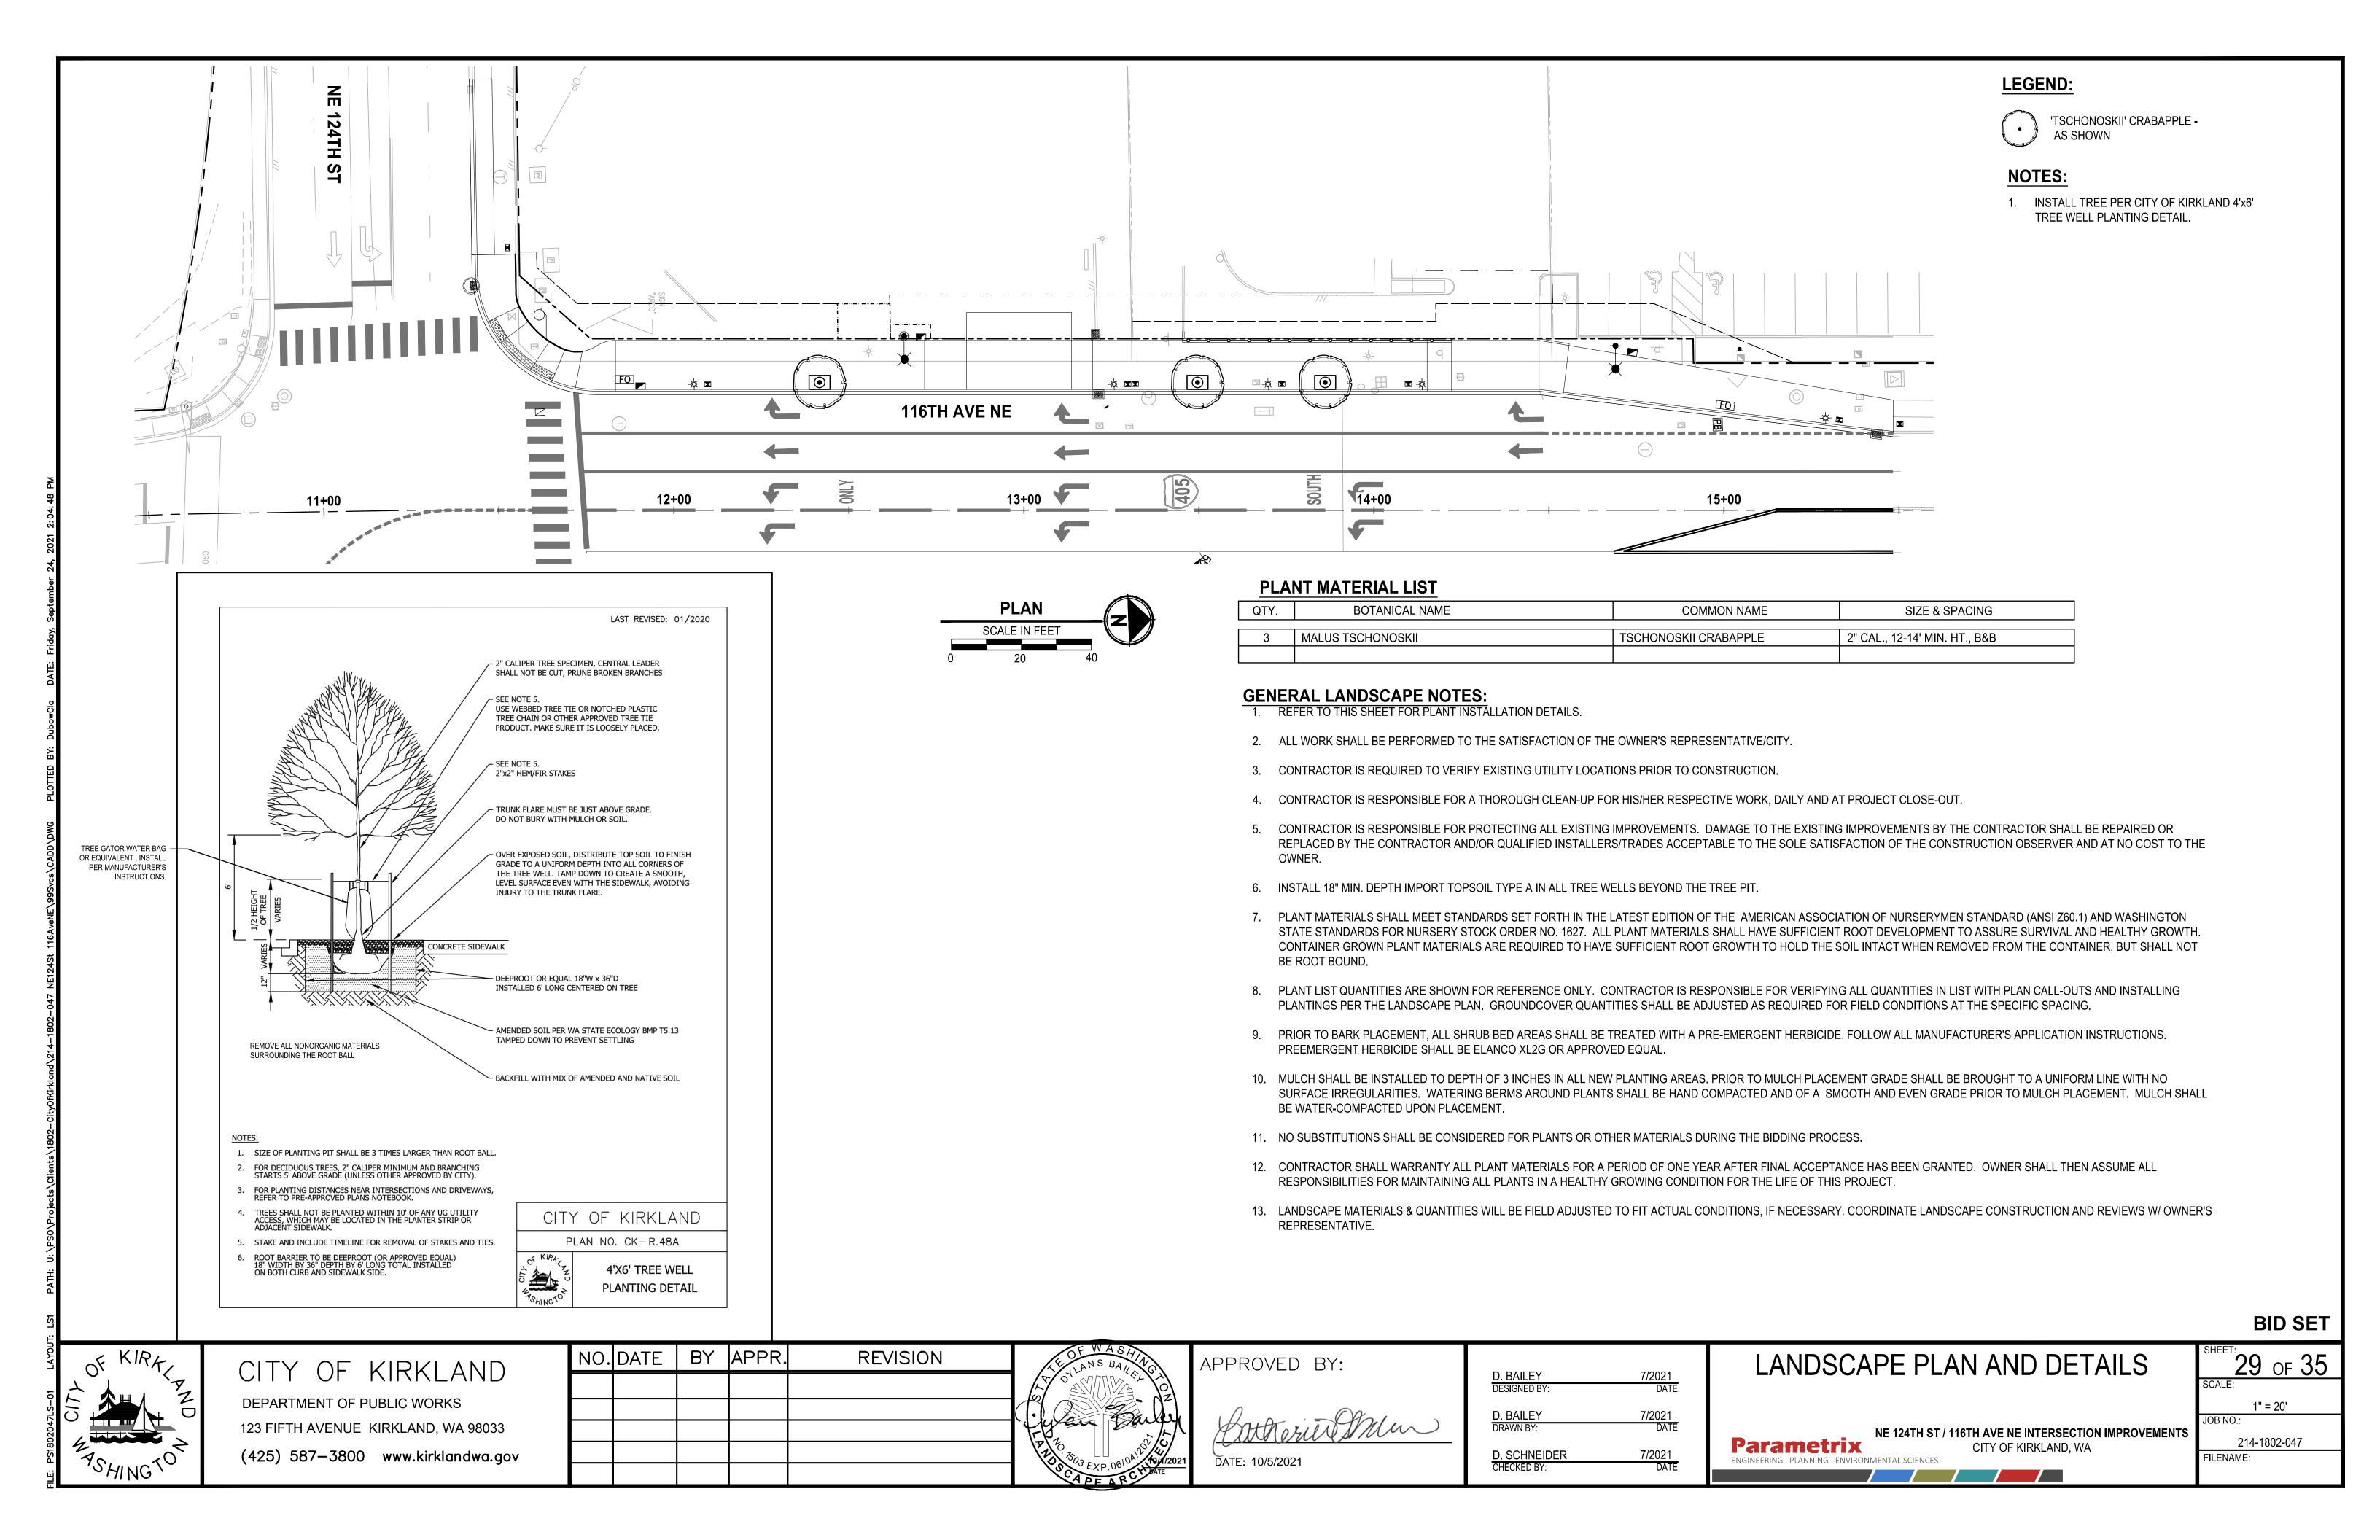
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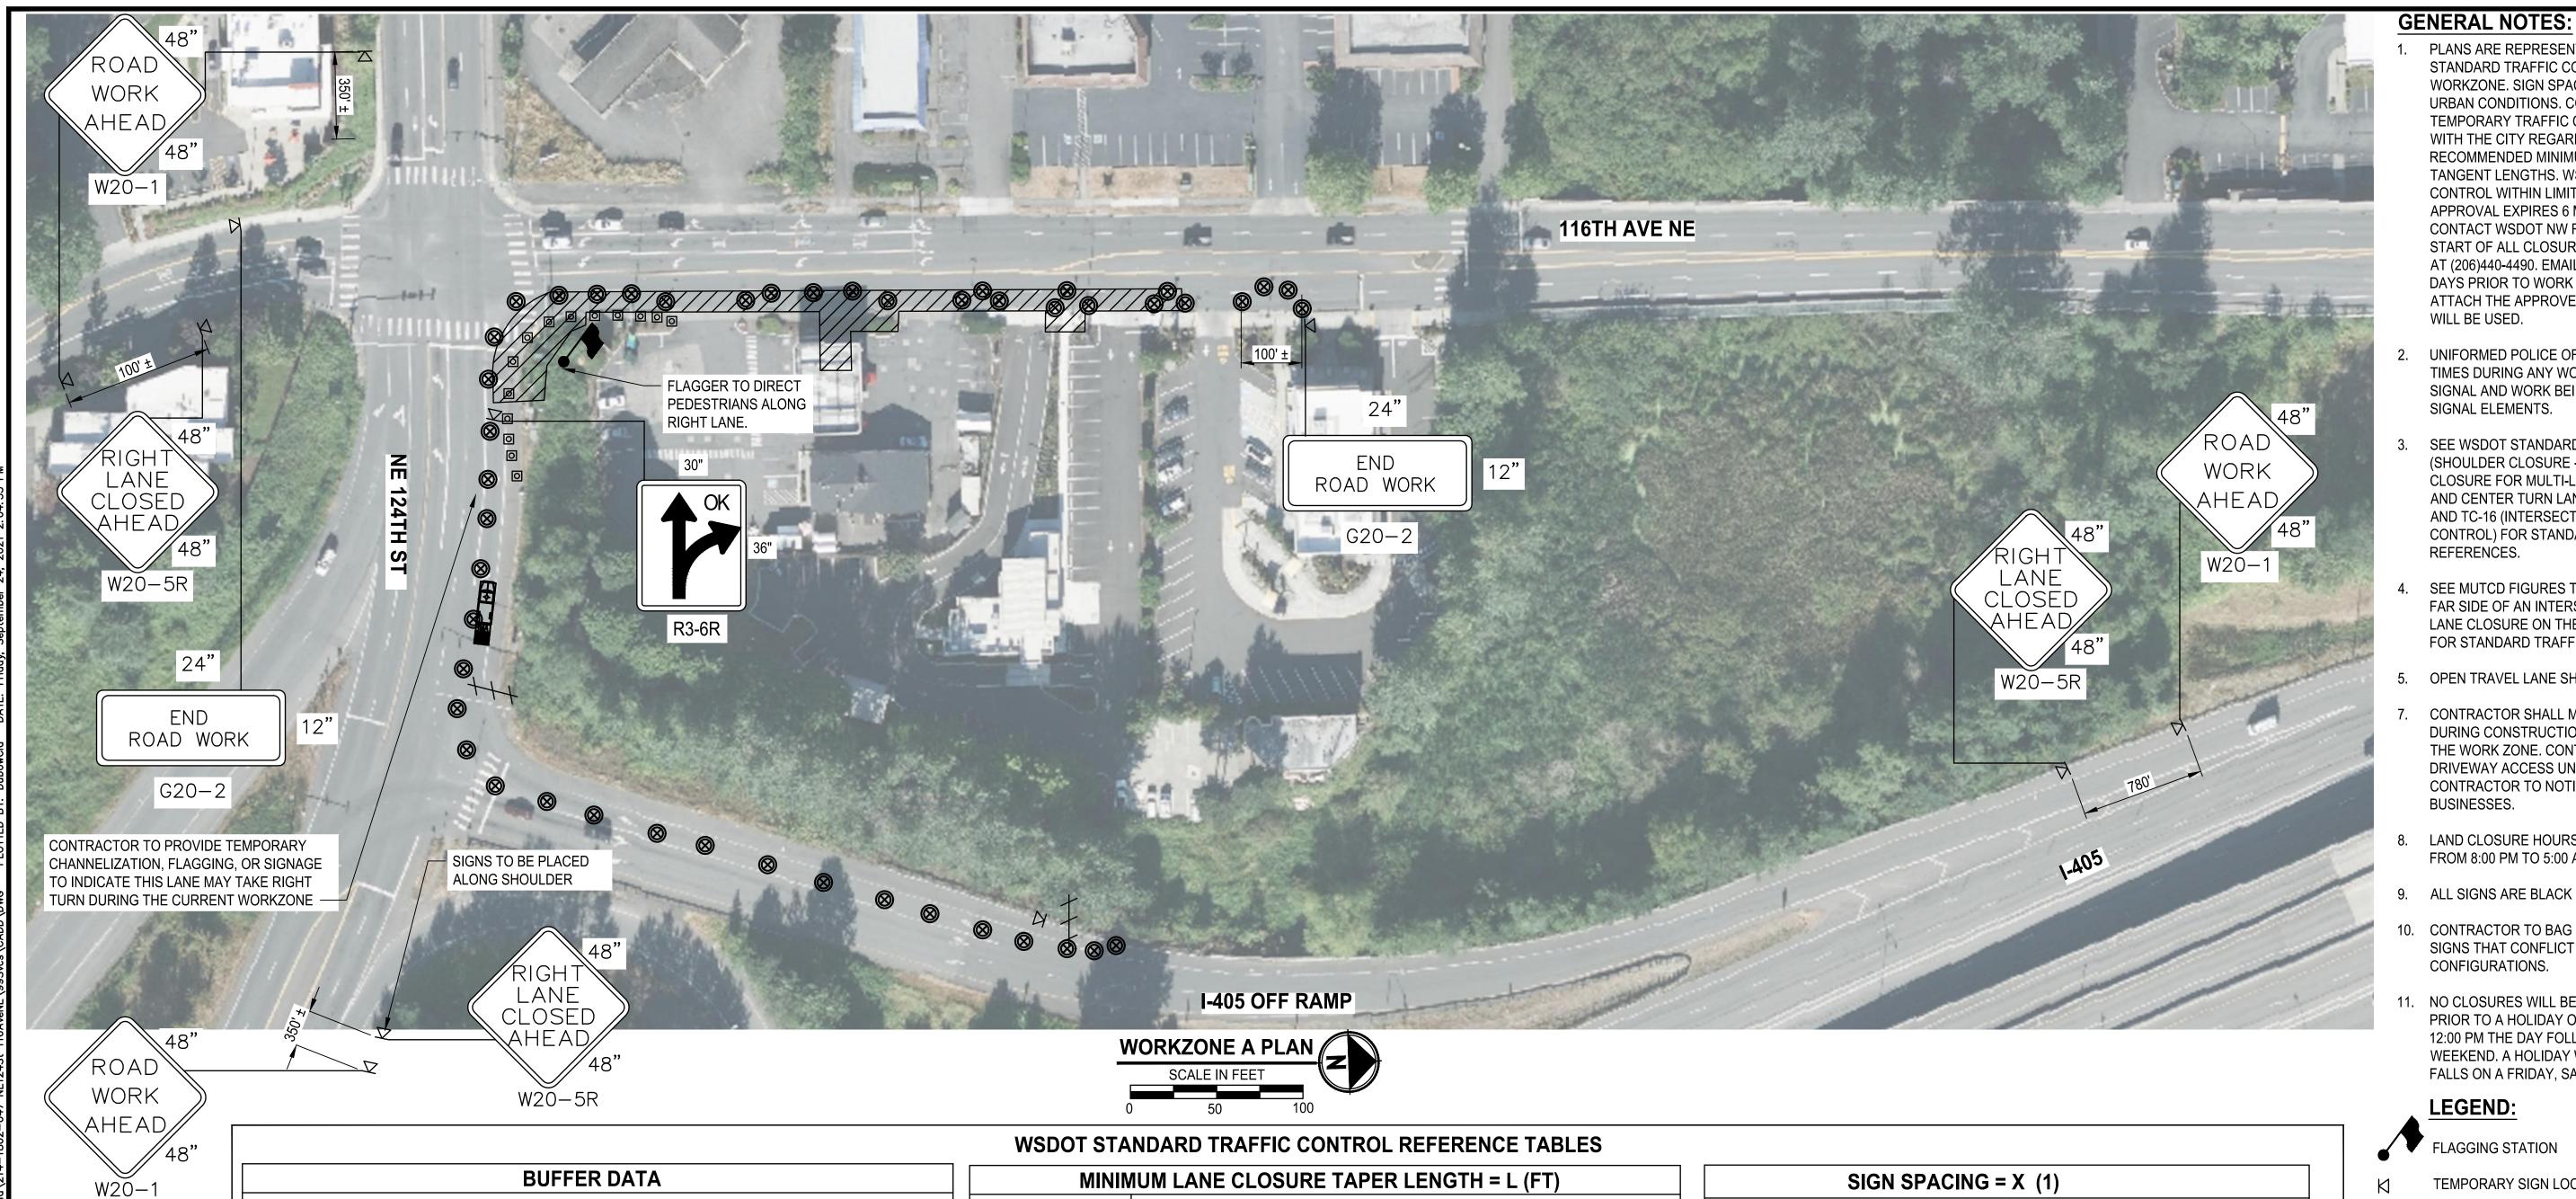
214-1802-047

ITS03.DWG

FILENAME:





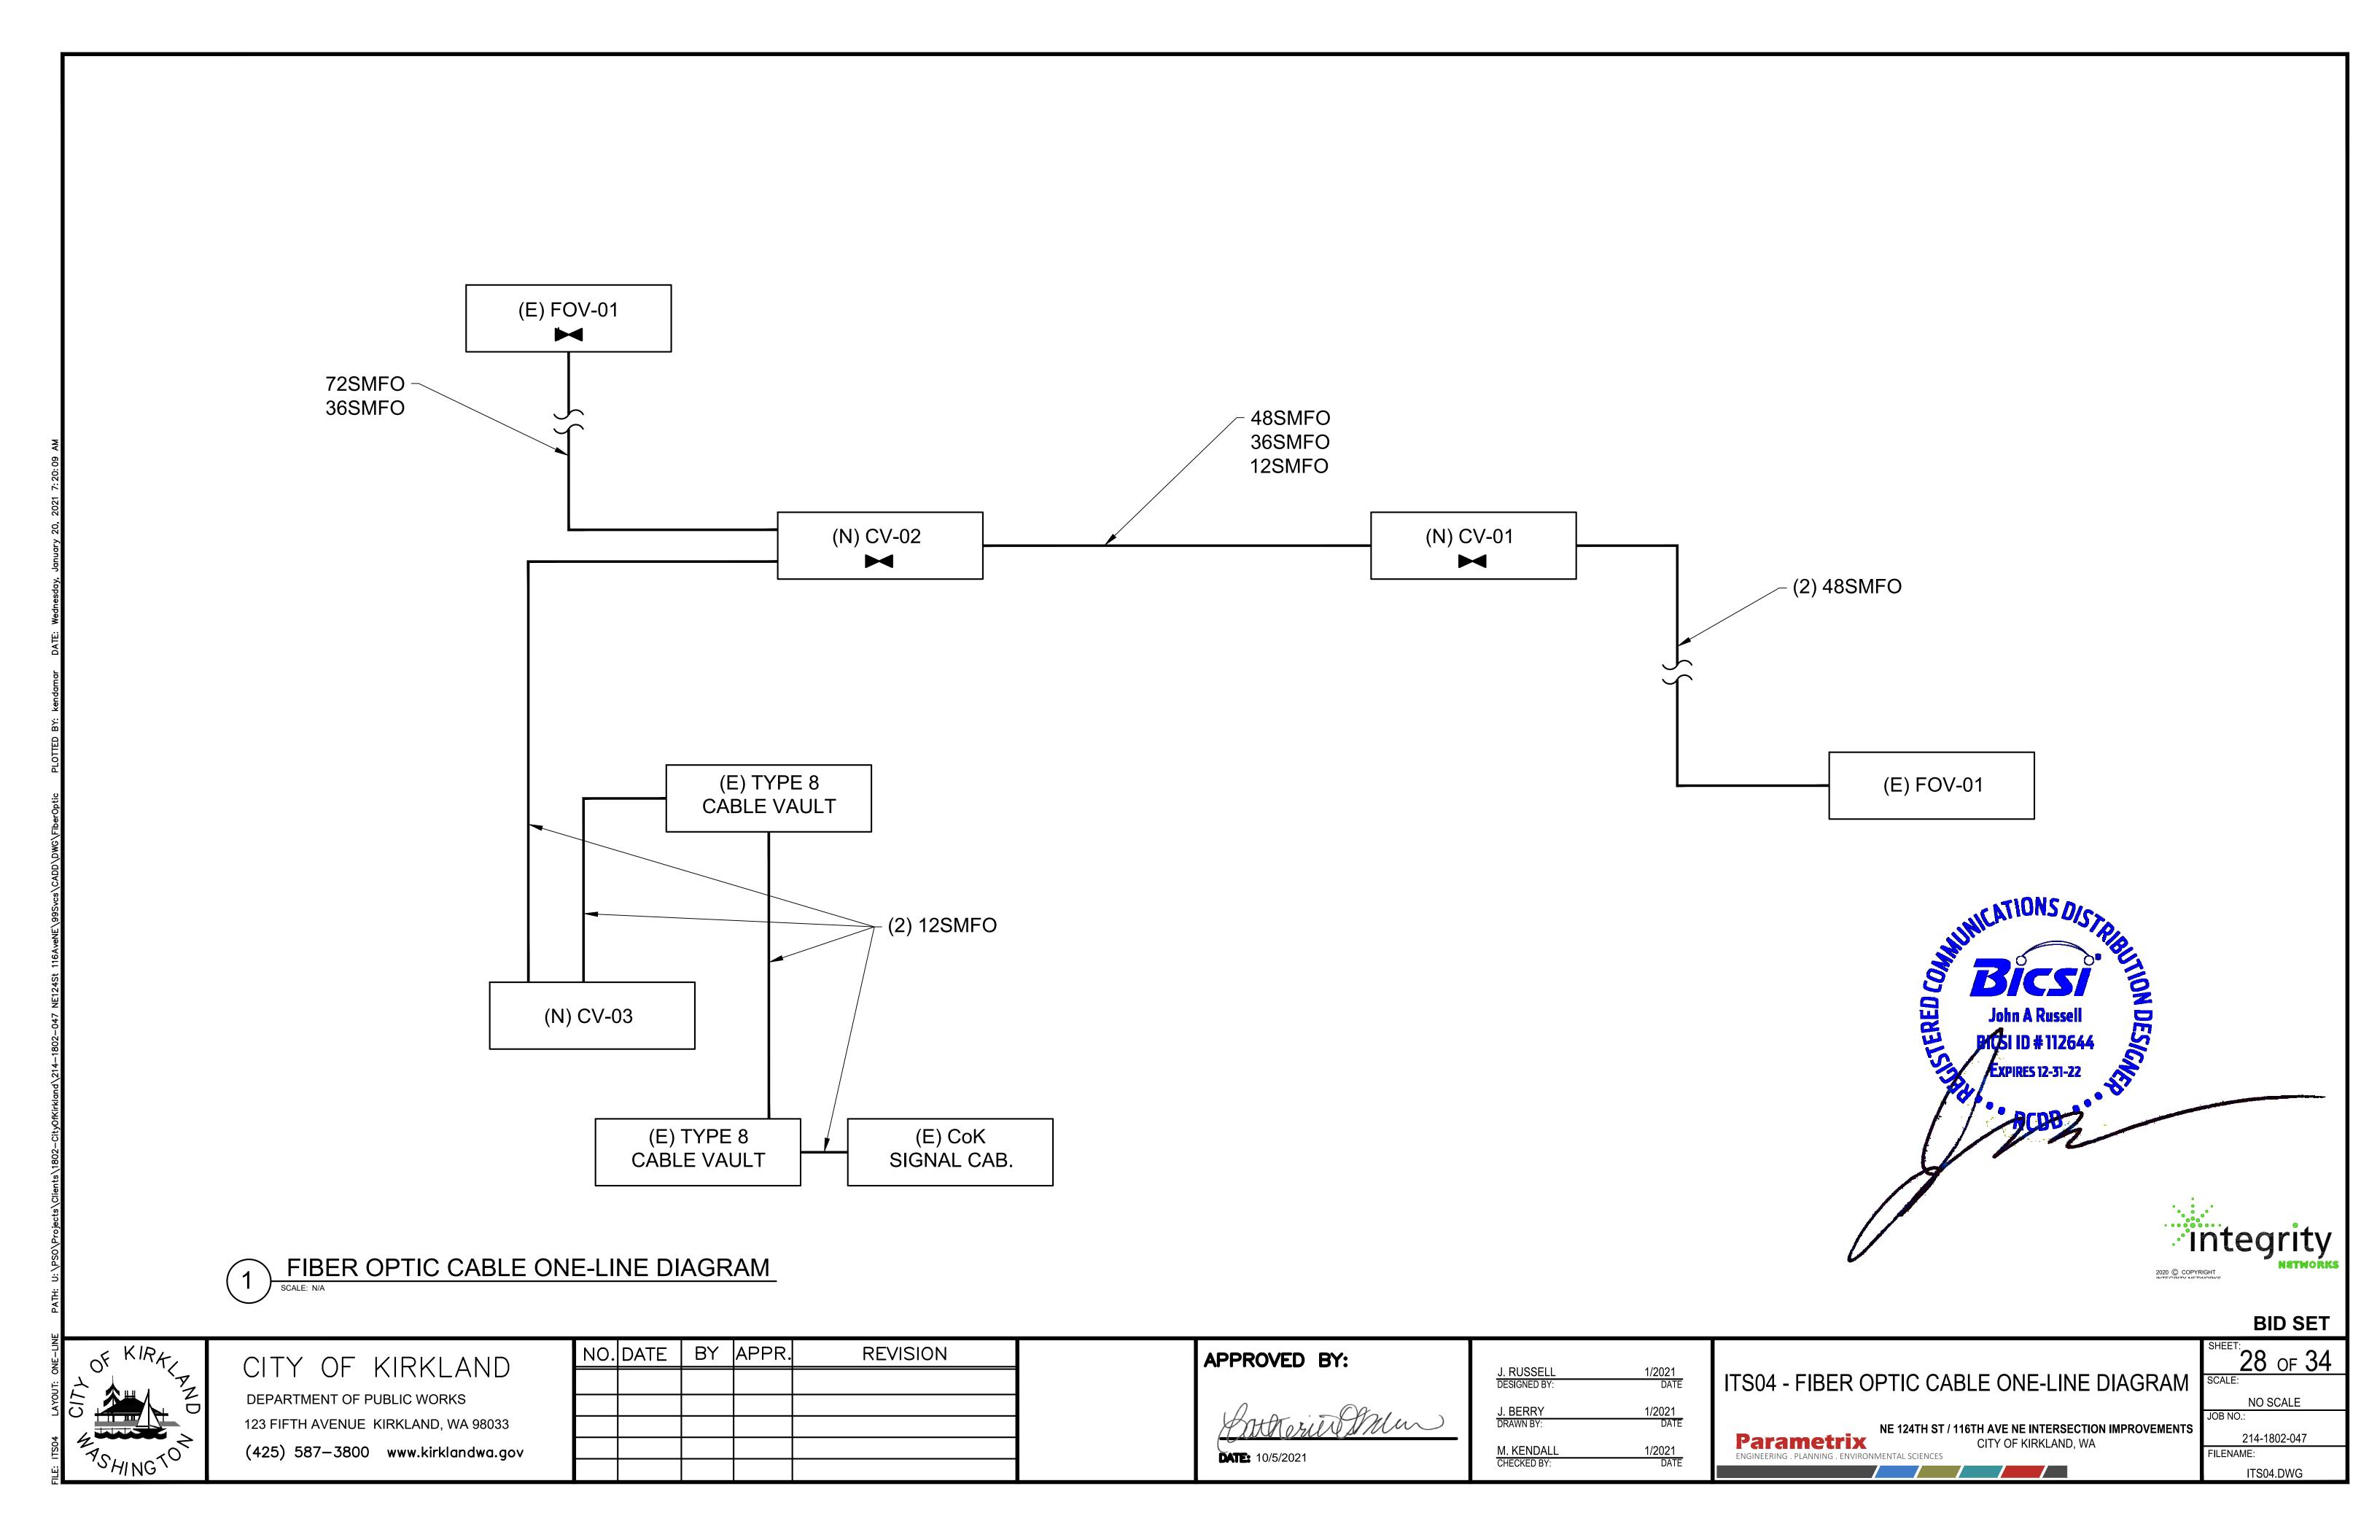

	BUFI	FER D	ATA						MI	NIMUM L	ANE C	CLOSU	IRE TA	APER	LENG	TH = L	. (FT)	
LONGITUDINAL BUFFER SPACE = B								LANE MIDTH (ET		POSTED SPEED (MPH)								
30	35	40	45	50	55	60	65	70	LANE WIDTH (FT)	25	30	35	40	45	50	55	60	
200	250	305	360	425	495	570	645	730	10	105	150	205	270	450	500	550	_	Ī
E AT	TENUA	ATOR	ROLL	OLL AHEAD DISTANCE = R				11	115	165	225	295	495	550	605	660	Ī	
/EIGHT) lbs.					VEHICLE 22,000		łТ		12	125	180	245	320	540	600	660	720	Ī
>	55 MPH		< 45 MPH 45-55 MPH > 55 MPH						MINIM	UM SHO	ULDE	R TAP	ER LE	NGTH	= L/3	(FT)		_
	172'		74'		100'		150'		SHOULDER			POSTED	SPEED	(MPH)				_

	MINIMUM SHOULDER TAPER LENGTH = L/3 (FT)														
SHOULDER		POSTED SPEED (MPH)													
WIDTH (FT)	25	30	35	40	45	50	55	60	65	70					
8'	40	40	60	90	-	-	=	-	-	-					
10'	40	60	90	90	-	-	=	-	-	-					
USE A 3 DEVICES TAPER FOR SHOULDERS LESS THEN 8'															

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- UNIFORMED POLICE OFFICER TO BE PRESENT AT ALL TIMES DURING ANY WORK REQUIRING SHUTDOWN OF SIGNAL AND WORK BEING PERFORMED ON THE TRAFFIC SIGNAL ELEMENTS.
- SEE WSDOT STANDARD TRAFFIC CONTROL PLANS TC5 (SHOULDER CLOSURE - LOW SPEEDS), TC-3 (SINGLE-LANE CLOSURE FOR MULTI-LANE ROADWAYS), TC-11 (LEFT LANE AND CENTER TURN LANE CLOSURE - 5 LANE ROADWAY), AND TC-16 (INTERSECTION PEDESTRIAN TRAFFIC CONTROL) FOR STANDARD TRAFFIC CONTROL DESIGN REFERENCES.
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LEGEND:

FLAGGING STATION

TEMPORARY SIGN LOCATION

CHANNELIZATION DEVICE

WORK ZONE

TYPE 3 BARRICADE

TRAFFIC SAFETY DRUM

SEQUENTIAL ARROW SIGN

PCMS PORTABLE CHANGEABLE MESSAGE SIGN

TRANSPORTABLE ATTENUATOR

PROTECTIVE VEHICLE

■ ■ ■ PEDESTRIAN CHANNELIZING DEVICES

BID SET



CITY OF KIRKLAND

25

155

HOST VEHICLE WEIGHT 9,900 TO 22,000 lbs.

45-55 MPH

TRANSPORTABLE ATTENUATOR ROLL

PROTECTIVE VEHICLE (WORK VEHICLE) = R

NO SPECIFIED DISTANCE REQUIRED

SPEED (MPH)

LENGTH (FT)

< 45 MPH

100'

DEPARTMENT OF PUBLIC WORKS 123 FIFTH AVENUE KIRKLAND, WA 98033 (425) 587-3800 www.kirklandwa.gov

BY APPR. NO. DATE **REVISION**



APPROVED BY:



65

780

D. SUSLIKOV DESIGNED BY:	7/2021 DATE
C. DUBOW	7/2021
D. SCHNEIDER	DATE 7/2021
CHECKED BY:	7/2021 DATE

RURAL ROADS & URBAN ARTERIALS

RURAL ROADS, URBAN ARTERIALS,

URBAN STREETS

25/30

RESIDENTIAL & BUSINESS DISTRICTS

CHANNELIZATION DEVICE

SPACING (FT)

20

MPH TAPER TANGENT

35 / 40 MPH

25 / 30 MPH

(1) ALL SPACING MAY BE ADJUSTED TO ACCOMMODATE INTERSECTIONS AND DRIVEWAYS.

 \mid (2) THIS SPACING MAY BE REDUCED IN URBAN AREAS TO FIT \mid ROADWAY CONDITIONS.

60

40

25 MPH OR LESS

350' ±

200' ± (2)

100' ± (2)


ENGINEERING . PLANNING . ENVIRONMENTAL SCIENCES

TEMPORARY TRAFFIC CONTROL WORKZONE A

NE 124TH ST / 116TH AVE NE INTERSECTION IMPROVEMENTS **Parametrix** CITY OF KIRKLAND, WA

30 of 35

1" = 20' 214-1802-047 FILENAME:

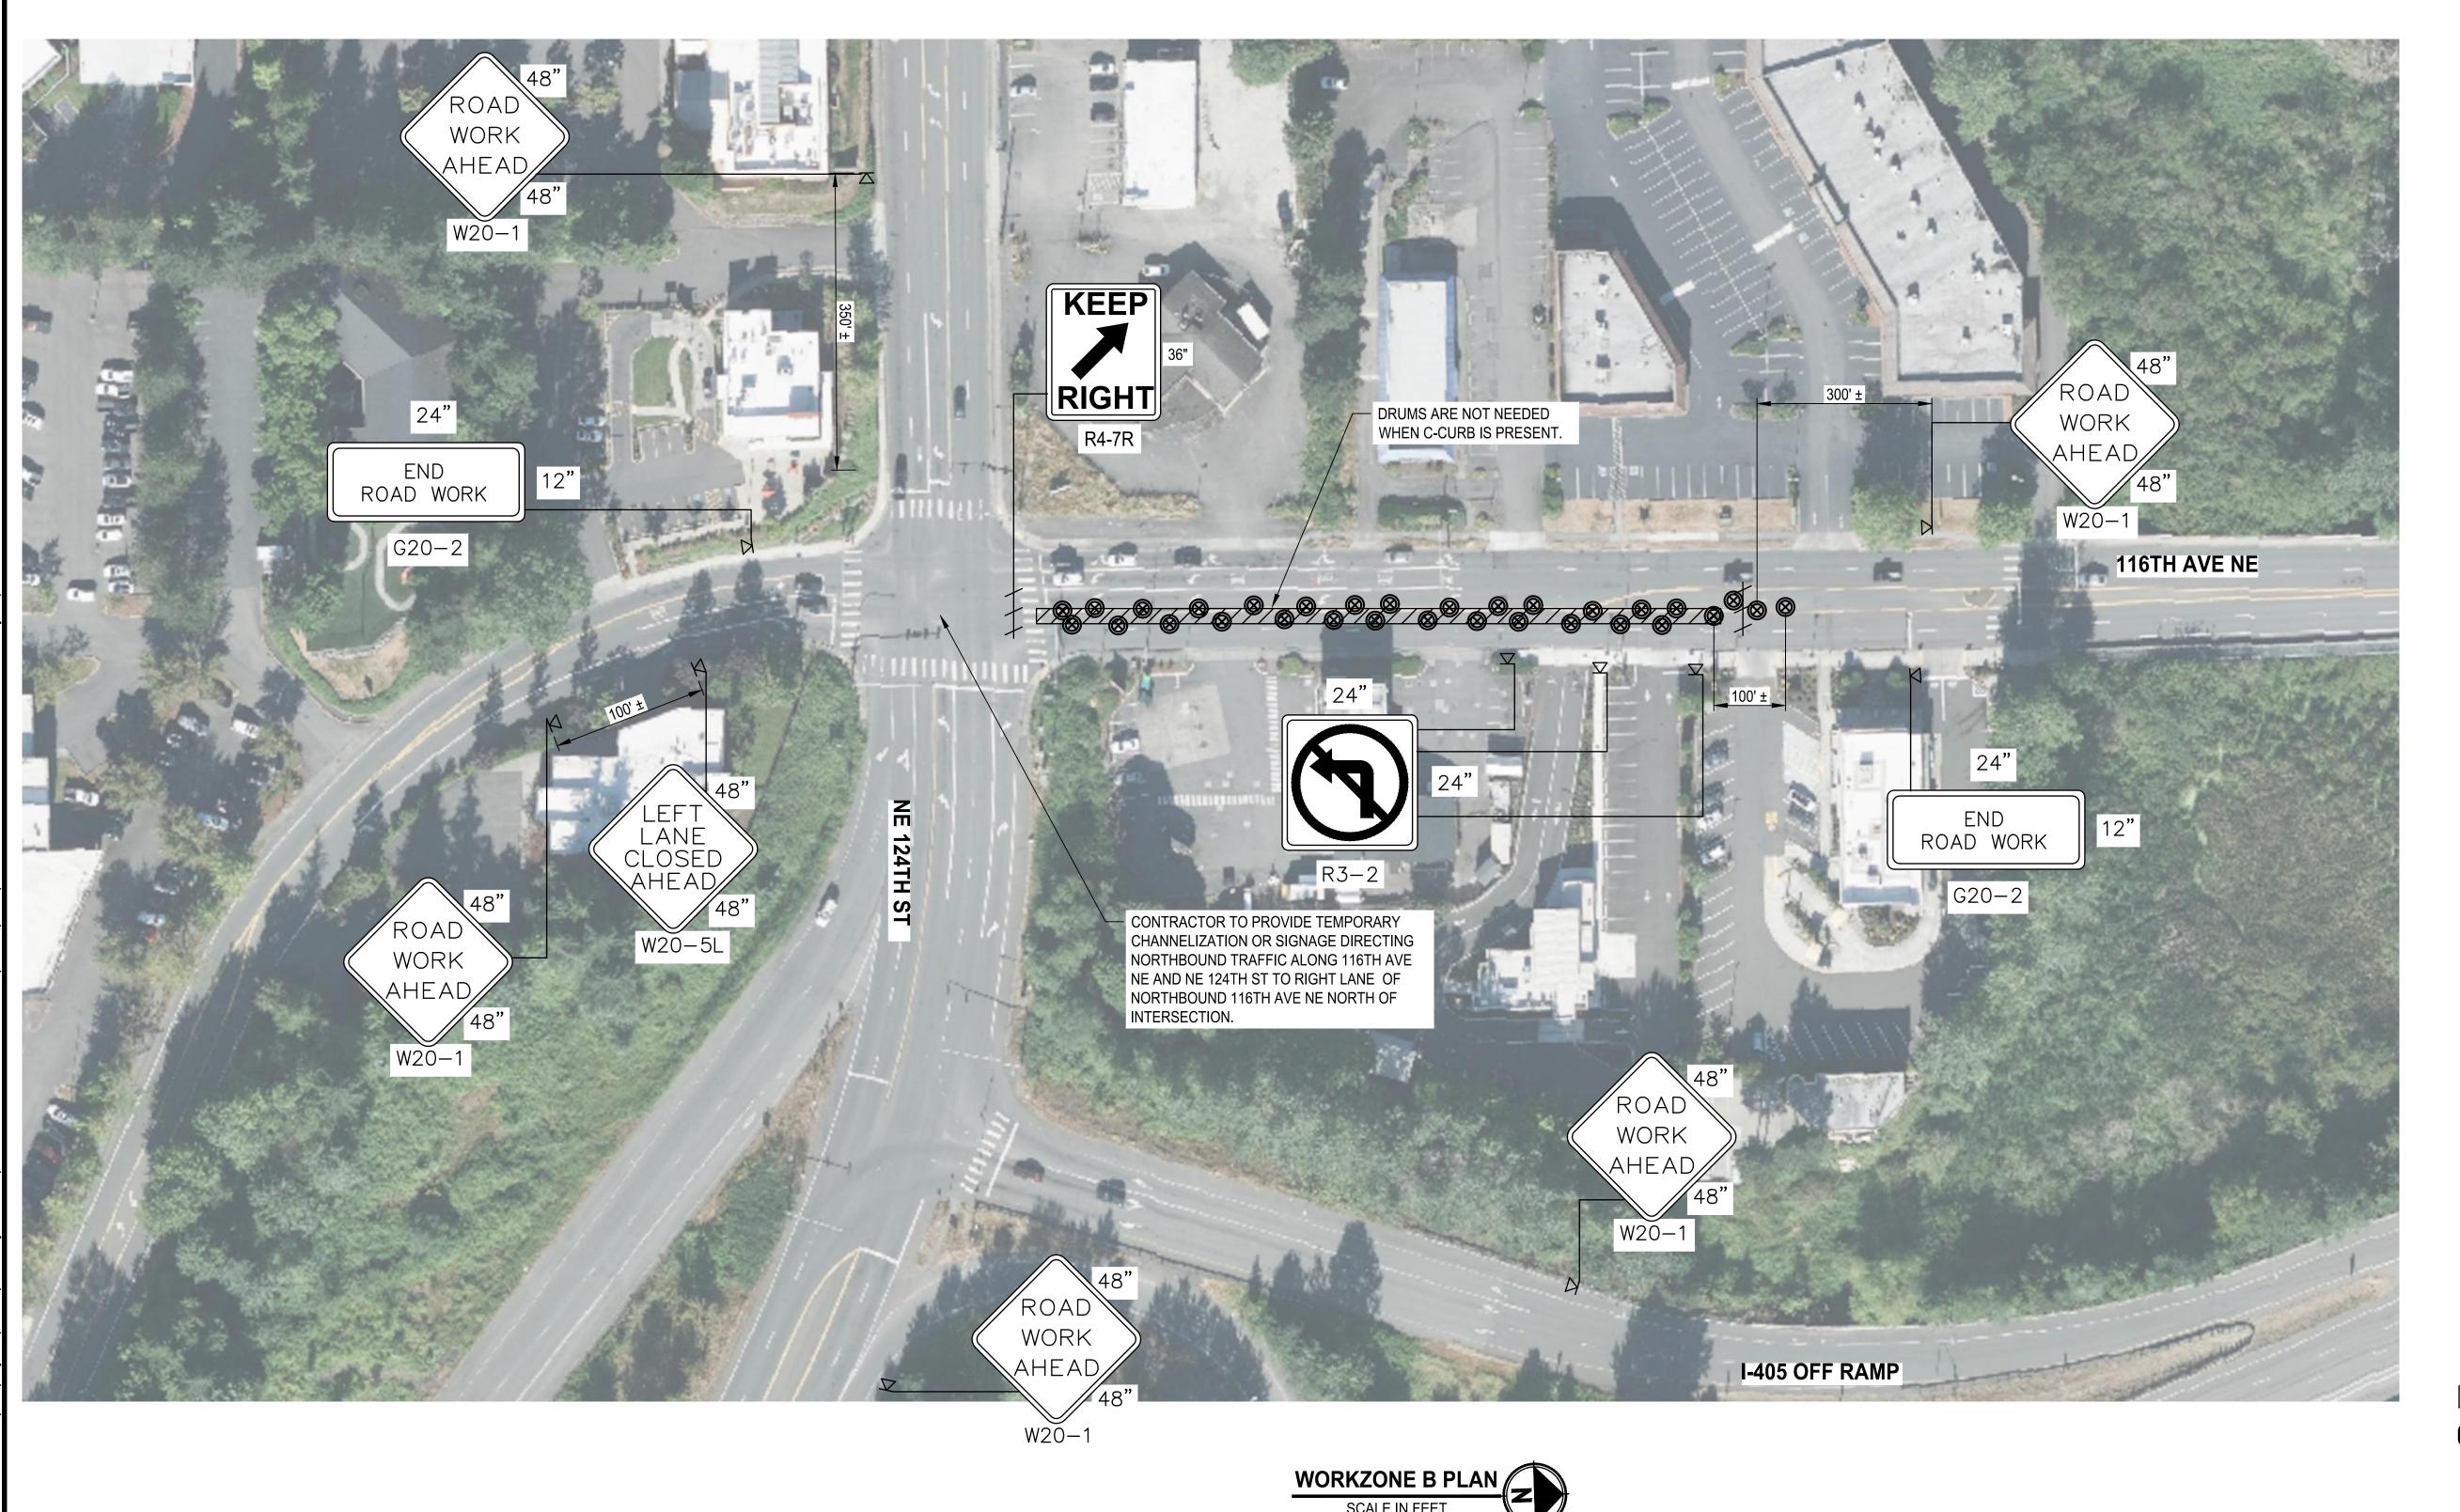

- 1. PLANS ARE REPRESENTATIVE OF RECOMMENDED STANDARD TRAFFIC CONTROL FOR EACH INDIVIDUAL WORKZONE. SIGN SPACING MAY BE REDUCE DUE TO URBAN CONDITIONS. CONTRACTOR TO PROVIDE TEMPORARY TRAFFIC CONTROL PLANS AND COORDINATE WITH THE CITY REGARDING DEVIANCIES TO THE RECOMMENDED MINIMUM CHANNELIZATION TAPER AND TANGENT LENGTHS. WSDOT IS APPROVING TRAFFIC CONTROL WITHIN LIMITED ACCESS ONLY. TRAFFIC APPROVAL EXPIRES 6 MONTHS AFTER THE SIGNED DATE. CONTACT WSDOT NW REGION RADIO 5 MINUTES PRIOR TO START OF ALL CLOSURES AND AGAIN AFTER REOPENING AT (206)440-4490. EMAIL JUAN REYES (WSDOT TRAFFIC) FIVE DAYS PRIOR TO WORK AT REYESJ@WSDOT.WA.GOV. ATTACH THE APPROVED TRAFFIC CONTROL PLAN THAT WILL BE USED.
- 2. UNIFORMED POLICE OFFICER TO BE PRESENT AT ALL TIMES DURING ANY WORK REQUIRING SHUTDOWN OF SIGNAL AND WORK BEING PERFORMED ON THE TRAFFIC SIGNAL ELEMENTS.
- 3. SEE WSDOT STANDARD TRAFFIC CONTROL PLANS TC5
 (SHOULDER CLOSURE LOW SPEEDS), TC-3 (SINGLE-LANE
 CLOSURE FOR MULTI-LANE ROADWAYS), TC-11 (LEFT LANE
 AND CENTER TURN LANE CLOSURE 5 LANE ROADWAY),
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LEGEND:

FLAGGING STATION

TEMPORARY SIGN LOCATION

CHANNELIZATION DEVICE

WORK ZONE

TYPE 3 BARRICADE

TRAFFIC SAFETY DRUM

SEQUENTIAL ARROW SIGN

PCMS PORTABLE CHANGEABLE MESSAGE SIGN

TRANSPORTABLE ATTENUATOR

PROTECTIVE VEHICLE

■■■ PEDESTRIAN CHANNELIZING DEVICES

BID SET



CITY OF KIRKLAND


DEPARTMENT OF PUBLIC WORKS

123 FIFTH AVENUE KIRKLAND, WA 98033

(425) 587–3800 www.kirklandwa.gov

NO. DATE BY APPR. REVISION



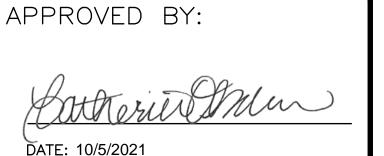

D. SUSLIKOV	7/2021
DESIGNED BY:	DATE
C. DUBOW	7/2021
DRAWN BY:	DATE
D. SCHNEIDER	7/2021
CHECKED BY:	DATE

TEMPORARY TRAFFIC CONTROL WORKZONE B

ENGINEERING . PLANNING . ENVIRONMENTAL SCIENCES


Parametrix

NE 124TH ST / 116TH AVE NE INTERSECTION IMPROVEMENTS

CITY OF KIRKLAND, WA

SHEET: 31 OF 35
SCALE: 1" = 20'

214-1802-047 FILENAME:

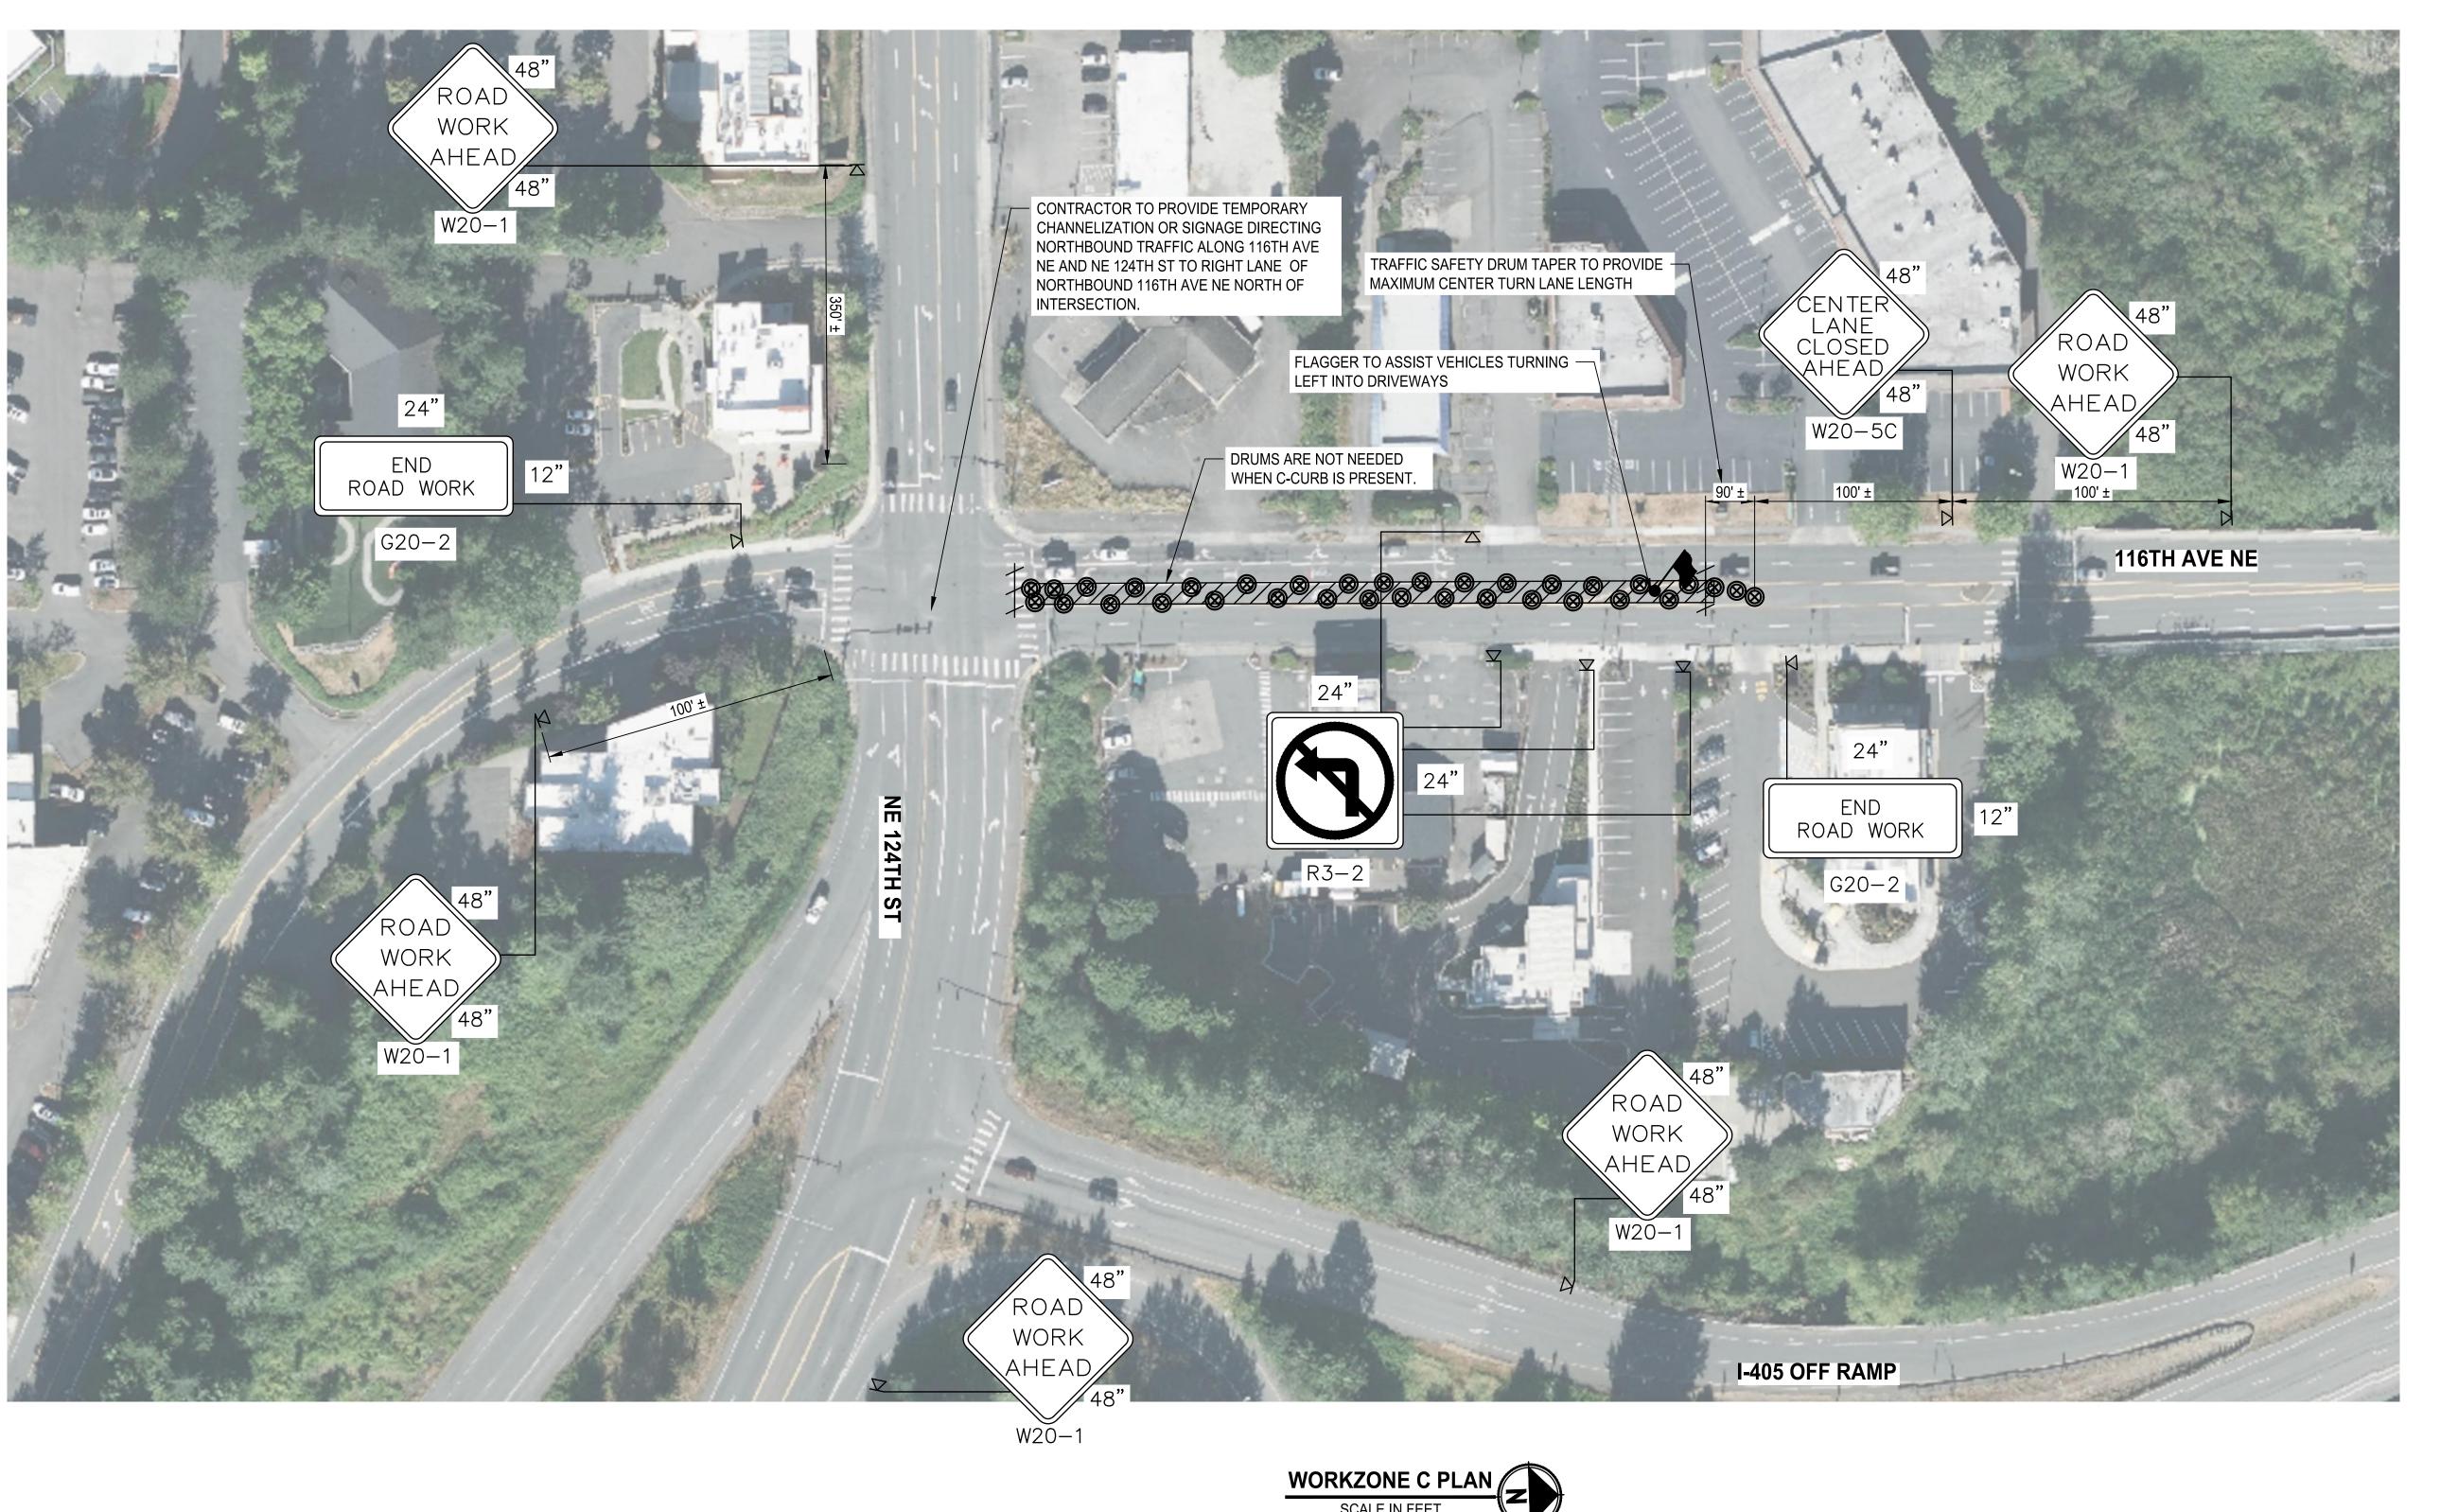

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FLAGGING STATION

TEMPORARY SIGN LOCATION

CHANNELIZATION DEVICE

WORK ZONE

TRAFFIC SAFETY DRUM

SEQUENTIAL ARROW SIGN

PCMS PORTABLE CHANGEABLE MESSAGE SIGN

TRANSPORTABLE ATTENUATOR

PROTECTIVE VEHICLE

■■■ PEDESTRIAN CHANNELIZING DEVICES

BID SET



CITY OF KIRKLAND


DEPARTMENT OF PUBLIC WORKS

123 FIFTH AVENUE KIRKLAND, WA 98033

(425) 587–3800 www.kirklandwa.gov

NO. DATE BY APPR. REVISION



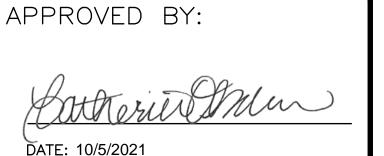

D. SUSLIKOV	7/2021
DESIGNED BY:	DATE
C. DUBOW	7/2021
DRAWN BY:	DATE
D. SCHNEIDER	7/2021
CHECKED BY:	DATE

TEMPORARY TRAFFIC CONTROL WORKZONE C

Parametrix

ENGINEERING . PLANNING . ENVIRONMENTAL SCIENCES

NE 124TH ST / 116TH AVE NE INTERSECTION IMPROVEMENTS
CITY OF KIRKLAND, WA

32 of 35


SCALE:


1" = 20'

JOB NO.:

214-1802-047

FILENAME:

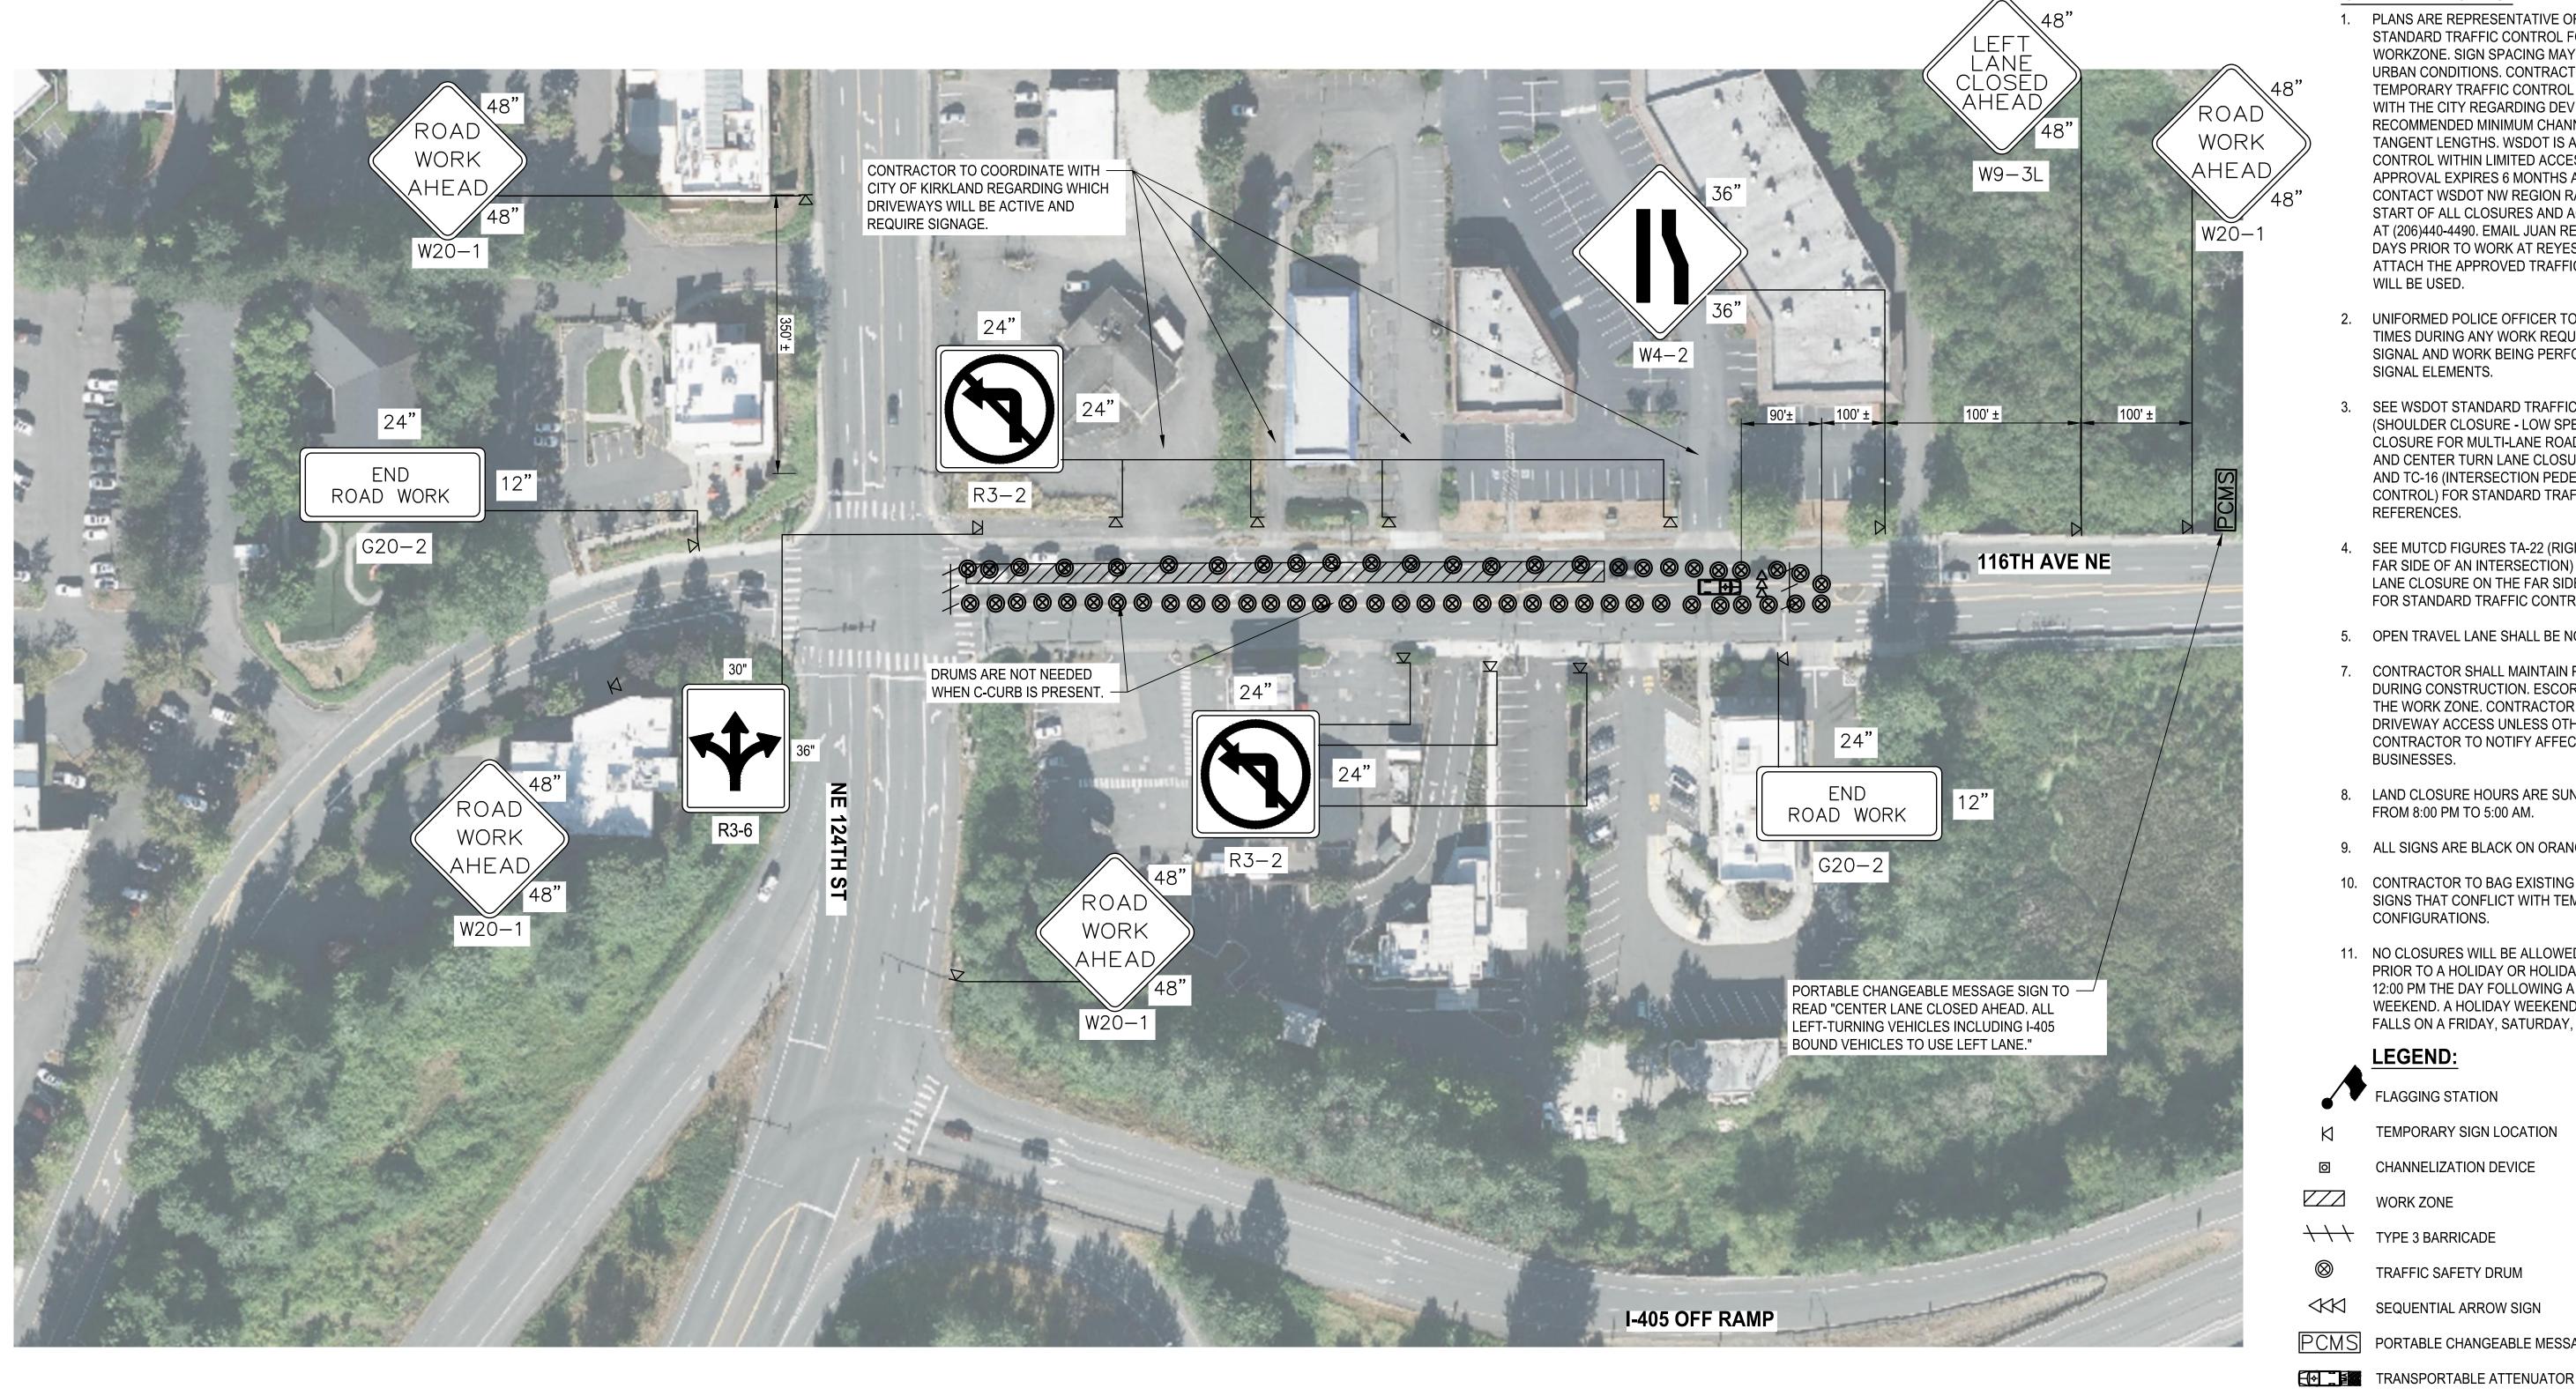

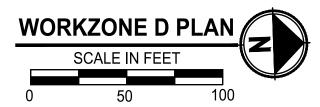

- 1. PLANS ARE REPRESENTATIVE OF RECOMMENDED STANDARD TRAFFIC CONTROL FOR EACH INDIVIDUAL WORKZONE. SIGN SPACING MAY BE REDUCE DUE TO URBAN CONDITIONS. CONTRACTOR TO PROVIDE TEMPORARY TRAFFIC CONTROL PLANS AND COORDINATE WITH THE CITY REGARDING DEVIANCIES TO THE RECOMMENDED MINIMUM CHANNELIZATION TAPER AND TANGENT LENGTHS. WSDOT IS APPROVING TRAFFIC CONTROL WITHIN LIMITED ACCESS ONLY. TRAFFIC APPROVAL EXPIRES 6 MONTHS AFTER THE SIGNED DATE. CONTACT WSDOT NW REGION RADIO 5 MINUTES PRIOR TO START OF ALL CLOSURES AND AGAIN AFTER REOPENING AT (206)440-4490. EMAIL JUAN REYES (WSDOT TRAFFIC) FIVE DAYS PRIOR TO WORK AT REYESJ@WSDOT.WA.GOV. ATTACH THE APPROVED TRAFFIC CONTROL PLAN THAT WILL BE USED.
- 2. UNIFORMED POLICE OFFICER TO BE PRESENT AT ALL TIMES DURING ANY WORK REQUIRING SHUTDOWN OF SIGNAL AND WORK BEING PERFORMED ON THE TRAFFIC SIGNAL ELEMENTS.
- 3. SEE WSDOT STANDARD TRAFFIC CONTROL PLANS TC5 (SHOULDER CLOSURE - LOW SPEEDS), TC-3 (SINGLE-LANE CLOSURE FOR MULTI-LANE ROADWAYS), TC-11 (LEFT LANE AND CENTER TURN LANE CLOSURE - 5 LANE ROADWAY), AND TC-16 (INTERSECTION PEDESTRIAN TRAFFIC CONTROL) FOR STANDARD TRAFFIC CONTROL DESIGN REFERENCES.
- 4. SEE MUTCD FIGURES TA-22 (RIGHT-HAND CLOSURE ON THE FAR SIDE OF AN INTERSECTION) AND TA-23 (LEFT-HAND LANE CLOSURE ON THE FAR SIDE OF AN INTERSECTION) FOR STANDARD TRAFFIC CONTROL DESIGN REFERENCES.
- 5. OPEN TRAVEL LANE SHALL BE NO LESS THAN 10 FEET
- 7. CONTRACTOR SHALL MAINTAIN PEDESTRIAN ACCESS DURING CONSTRUCTION. ESCORT PEDESTRIANS THROUGH THE WORK ZONE. CONTRACTOR SHALL MAINTAIN ALL DRIVEWAY ACCESS UNLESS OTHERWISE NOTED. CONTRACTOR TO NOTIFY AFFECTED RESIDENTS AND BUSINESSES.
- 8. LAND CLOSURE HOURS ARE SUNDAY THROUGH THURSDAY FROM 8:00 PM TO 5:00 AM.
- 9. ALL SIGNS ARE BLACK ON ORANGE.
- 10. CONTRACTOR TO BAG EXISTING LANE CONFIGURATION SIGNS THAT CONFLICT WITH TEMPORARY TRAFFIC CONFIGURATIONS.
- 11. NO CLOSURES WILL BE ALLOWED FROM 12:00 PM THE DAY PRIOR TO A HOLIDAY OR HOLIDAY WEEKENDS THROUGH 12:00 PM THE DAY FOLLOWING A HOLIDAY OR HOLIDAY WEEKEND. A HOLIDAY WEEKEND OCCURS WHEN A HOLIDAY FALLS ON A FRIDAY, SATURDAY, SUNDAY, OR MONDAY.

LEGEND:

FLAGGING STATION

TEMPORARY SIGN LOCATION

CHANNELIZATION DEVICE

WORK ZONE

TRAFFIC SAFETY DRUM

SEQUENTIAL ARROW SIGN

PCMS PORTABLE CHANGEABLE MESSAGE SIGN

PROTECTIVE VEHICLE

■ ■ ■ ■ PEDESTRIAN CHANNELIZING DEVICES

BID SET




CITY OF KIRKLAND

DEPARTMENT OF PUBLIC WORKS 123 FIFTH AVENUE KIRKLAND, WA 98033 (425) 587-3800 www.kirklandwa.gov

NO.	DATE	BY	APPR.	REVISION	



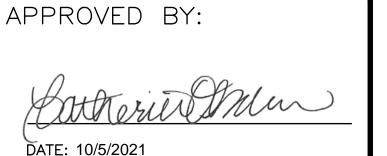

D. SUSLIKOV	7/2021
DESIGNED BY:	DATE
C. DUBOW	7/2021
DRAWN BY:	DATE
D. SCHNEIDER	7/2021
CHECKED BY:	DATE

TEMPORARY TRAFFIC CONTROL WORKZONE D

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